SHEET INDEX

C-0	COVER SHEET
C-1	EXISTING CONDITIONS PLOT PLAN
C-2	EROSION CONTROL AND DEMO PLAN
C-3	GARBAGE REMOVAL AND SITE PLAN
C-4	GRADING AND UTILITIES PLAN
C-5	VEHICLE SIMULATION
C-6	DETAILS SHEET 1
C-7	DETAILS SHEET 2

PARKING SUMMARY

PARKING CODE B-DWELLING, MULTIFAMILY - REQUIRED 2 SPACES PER DWELLING UNIT = 7 UNITS x 2 = 14 SPACES

	<u>REQUIRED</u>	<u>PROPOSED</u>	<u>RELIEF REQUIRED</u>
PARKING	14	14	Ν

ZONING SUMMARY


URBAN RESIDENCE C (UR-C)

	REQUIRED	PROVIDED	<u>RELIEF</u> <u>REQUIRED</u>
MIN LOT AREA	⁽¹⁾ 13,500 SF	13,186 SF	Y
MIN. LOT FRONTAGE & LOT WIDTH	100'	65.6'	Y
MIN LOT DEPTH	90'	201'	Ν
MIN FRONT YARD	20'	13.4'	Y
MIN SIDE YARD	10'	10'	Ν
MIN REAR YARD	15'	43.75'	Ν
MAX HEIGHT	50'	⁽²⁾ ±32'	Ν
MAX STORIES	4	3	Ν
MAX LOT COVERAGE	50%	37.8%	Ν
MAX FLOOR AREA	1	0.997	Ν
MIN OPEN SPACE	20%	21.2%	Ν

(1) 6,000 SF + 1,250 SF X 6 UNITS = 13,500 SF ⁽²⁾ REFER TO ARCHITECTURAL PLANS

VARIANCE LIST


- 1. MINIMUM LOT AREA FOR SEVEN (7) UNIT MULTI-FAMILY.
- 2. MINIMUM LOT FRONTAGE IN UR-C ZONING DISTRICT.
- 3. MINIMUM FRONT YARD SETBACK.

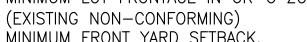



<u>SITE PLAN SET</u> PROPOSED 7-UNIT RESIDENTIAL MULTI-FAMILY BUILDING

<u>PROJECT LOCATION:</u> 373 PLEASANT STREET MELROSE, MA 02176

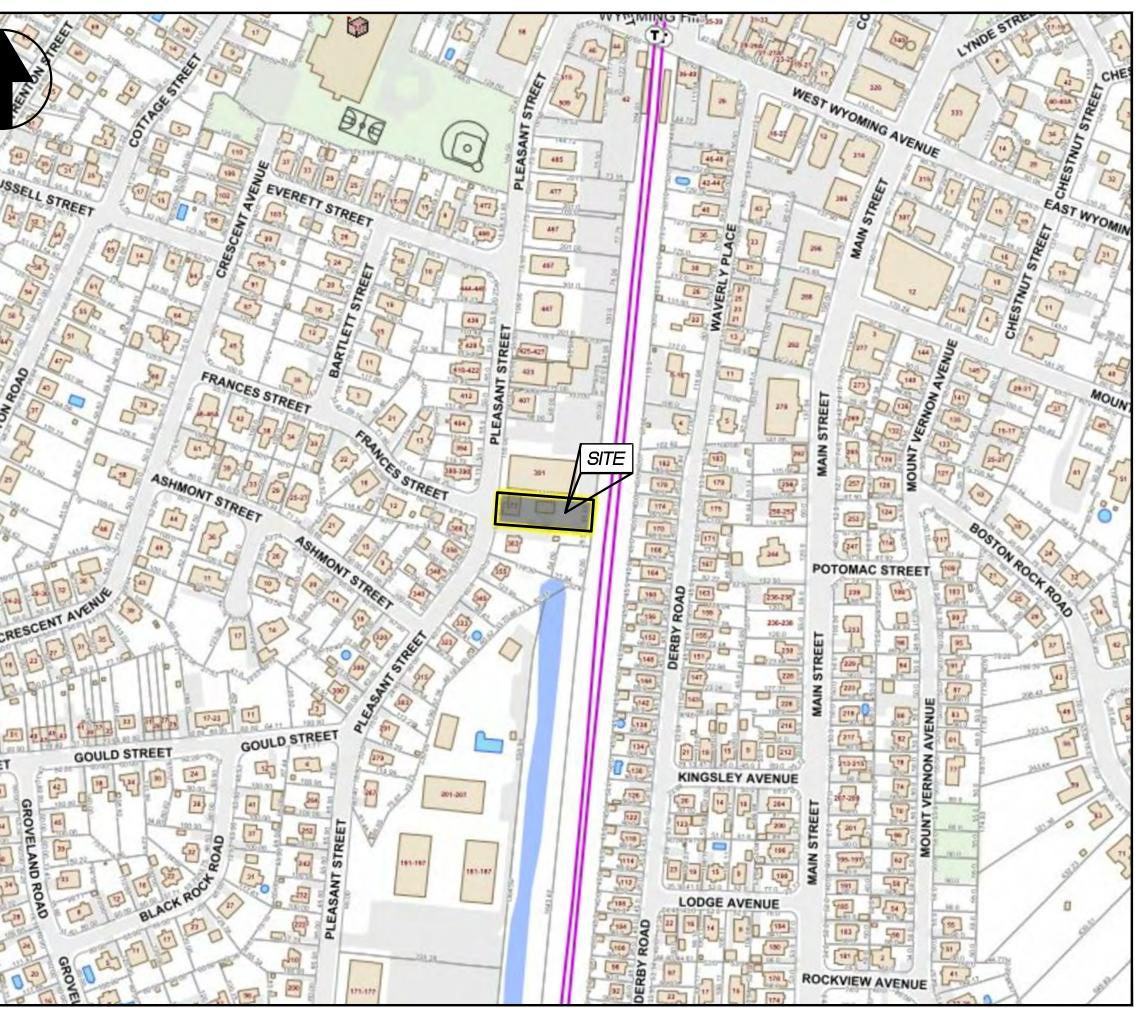

LOCUS MAP SCALE: 1'' = 200'

<u>PREPARED FOR:</u> (APPLICANT) BOGHOS PROPERTIES 655 E 2ND STREET, UNIT 204 BOSTON, MA 02127



PROPERTY INFORMATION

ADDRESS 373 PLEASANT STREET MELROSE, MA 02176

RECORD OWNER RAYMOND ANTHONY BOGHOS 655 E 2ND STREET, UNIT 204 BOSTON, MA 02127

<u>LOT SIZE</u> 13,186 S.F. (0.30± AC.)

<u>PARCEL ID</u> B5-0-122

ZONING DISTRICT URBAN RESIDENCE C (UR-C)

GENERAL NOTES

- 1. THE EXISTING PARCEL CONTAINS A SINGLE-FAMILY RESIDENTIAL DWELLING AND THE PROPOSED PROJECT IS TO CONSTRUCT A MULTI-FAMILY BUILDING THAT CONTAINS SEVEN (7) DWELLING UNITS.
- 2. BOUNDARY, TOPOGRAPHIC, AND PLANIMETRIC INFORMATION WAS OBTAINED FROM AN ON-THE-GROUND SURVEY PERFORMED AND COMPLETED BY FODERA ENGINEERING.
- 3. THE PROJECT IS LOCATED WITHIN THE RIVERFRONT AREA OF SPOT POND BROOK. SPOT POND BROOK IS A HUMAN-MADE CHANNEL AND WAS DELINEATED BY NORSE ENVIRONMENTAL IN NOVEMBER 2020.
- 4. THE SITE DOES NOT CONTAIN AREAS SUBJECT TO 1% ANNUAL CHANCE OF FLOODING AND IS IN ZONE "X" AS DETERMINED BY FEMA FLOOD INSURANCE RATE MAP (FIRM) 25017C0429E WITH AN EFFECTIVE DATE OF 6/4/2010.

UTILITIES AND CONTACTS

<u>CABLE</u>

COMCAST CABLE CORPORATION 5 OMNI WAY CHELMSFORD, MA 01824 ATTN: TED QUINT 978-848-5163 ted_quint@comcast.com

<u>GAS</u>

NATIONAL GRID GAS 40 SYLVAN ROAD WALTHAM, MA 02451 ATTN: MELISSA OWENS 781-907-2845 melissa.owens@nationalgrid.com

WATER AND SEWER

MELROSE DPW-WATER & SEWER 562 MAIN STREET MELROSE, MA 02176 781-979-4175

<u>ELECTRIC</u>


NATIONAL GRID ELECTRIC 548 HAYDENVILLE ROAD LEEDS, MA 01053 ATTN: SANDRA ANNIS 413-582-7424 sandra.annis@nationalgrid.com

<u>TELEPHONE</u>

VERIZON 385 MYLES STANDISH BLVD. TAUNTON, MA 02780 ATTN: KAREN MEALEY 774-409-3160 karen.m.mealey@verizon.com


<u>FIRE ALARM</u>

MELROSE FIRE ALARM 576 MAIN STREET MELROSE, MA 02176 781-979-4404

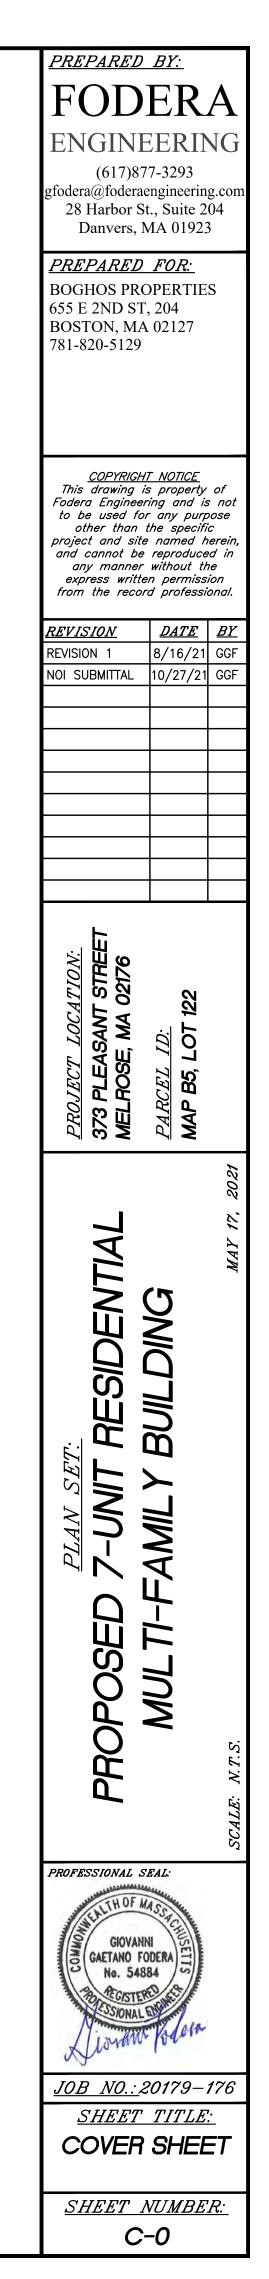

REVISION BLOCK

<u>REVISION SET</u>	<u>REVISION DATE</u>	COMPLETED BY
REVISION 1	8/16/2021	GGF
NOI SUBMITTAL	10/27/2021	GGF
_	-	-
_	-	-
_	_	_
_	_	_

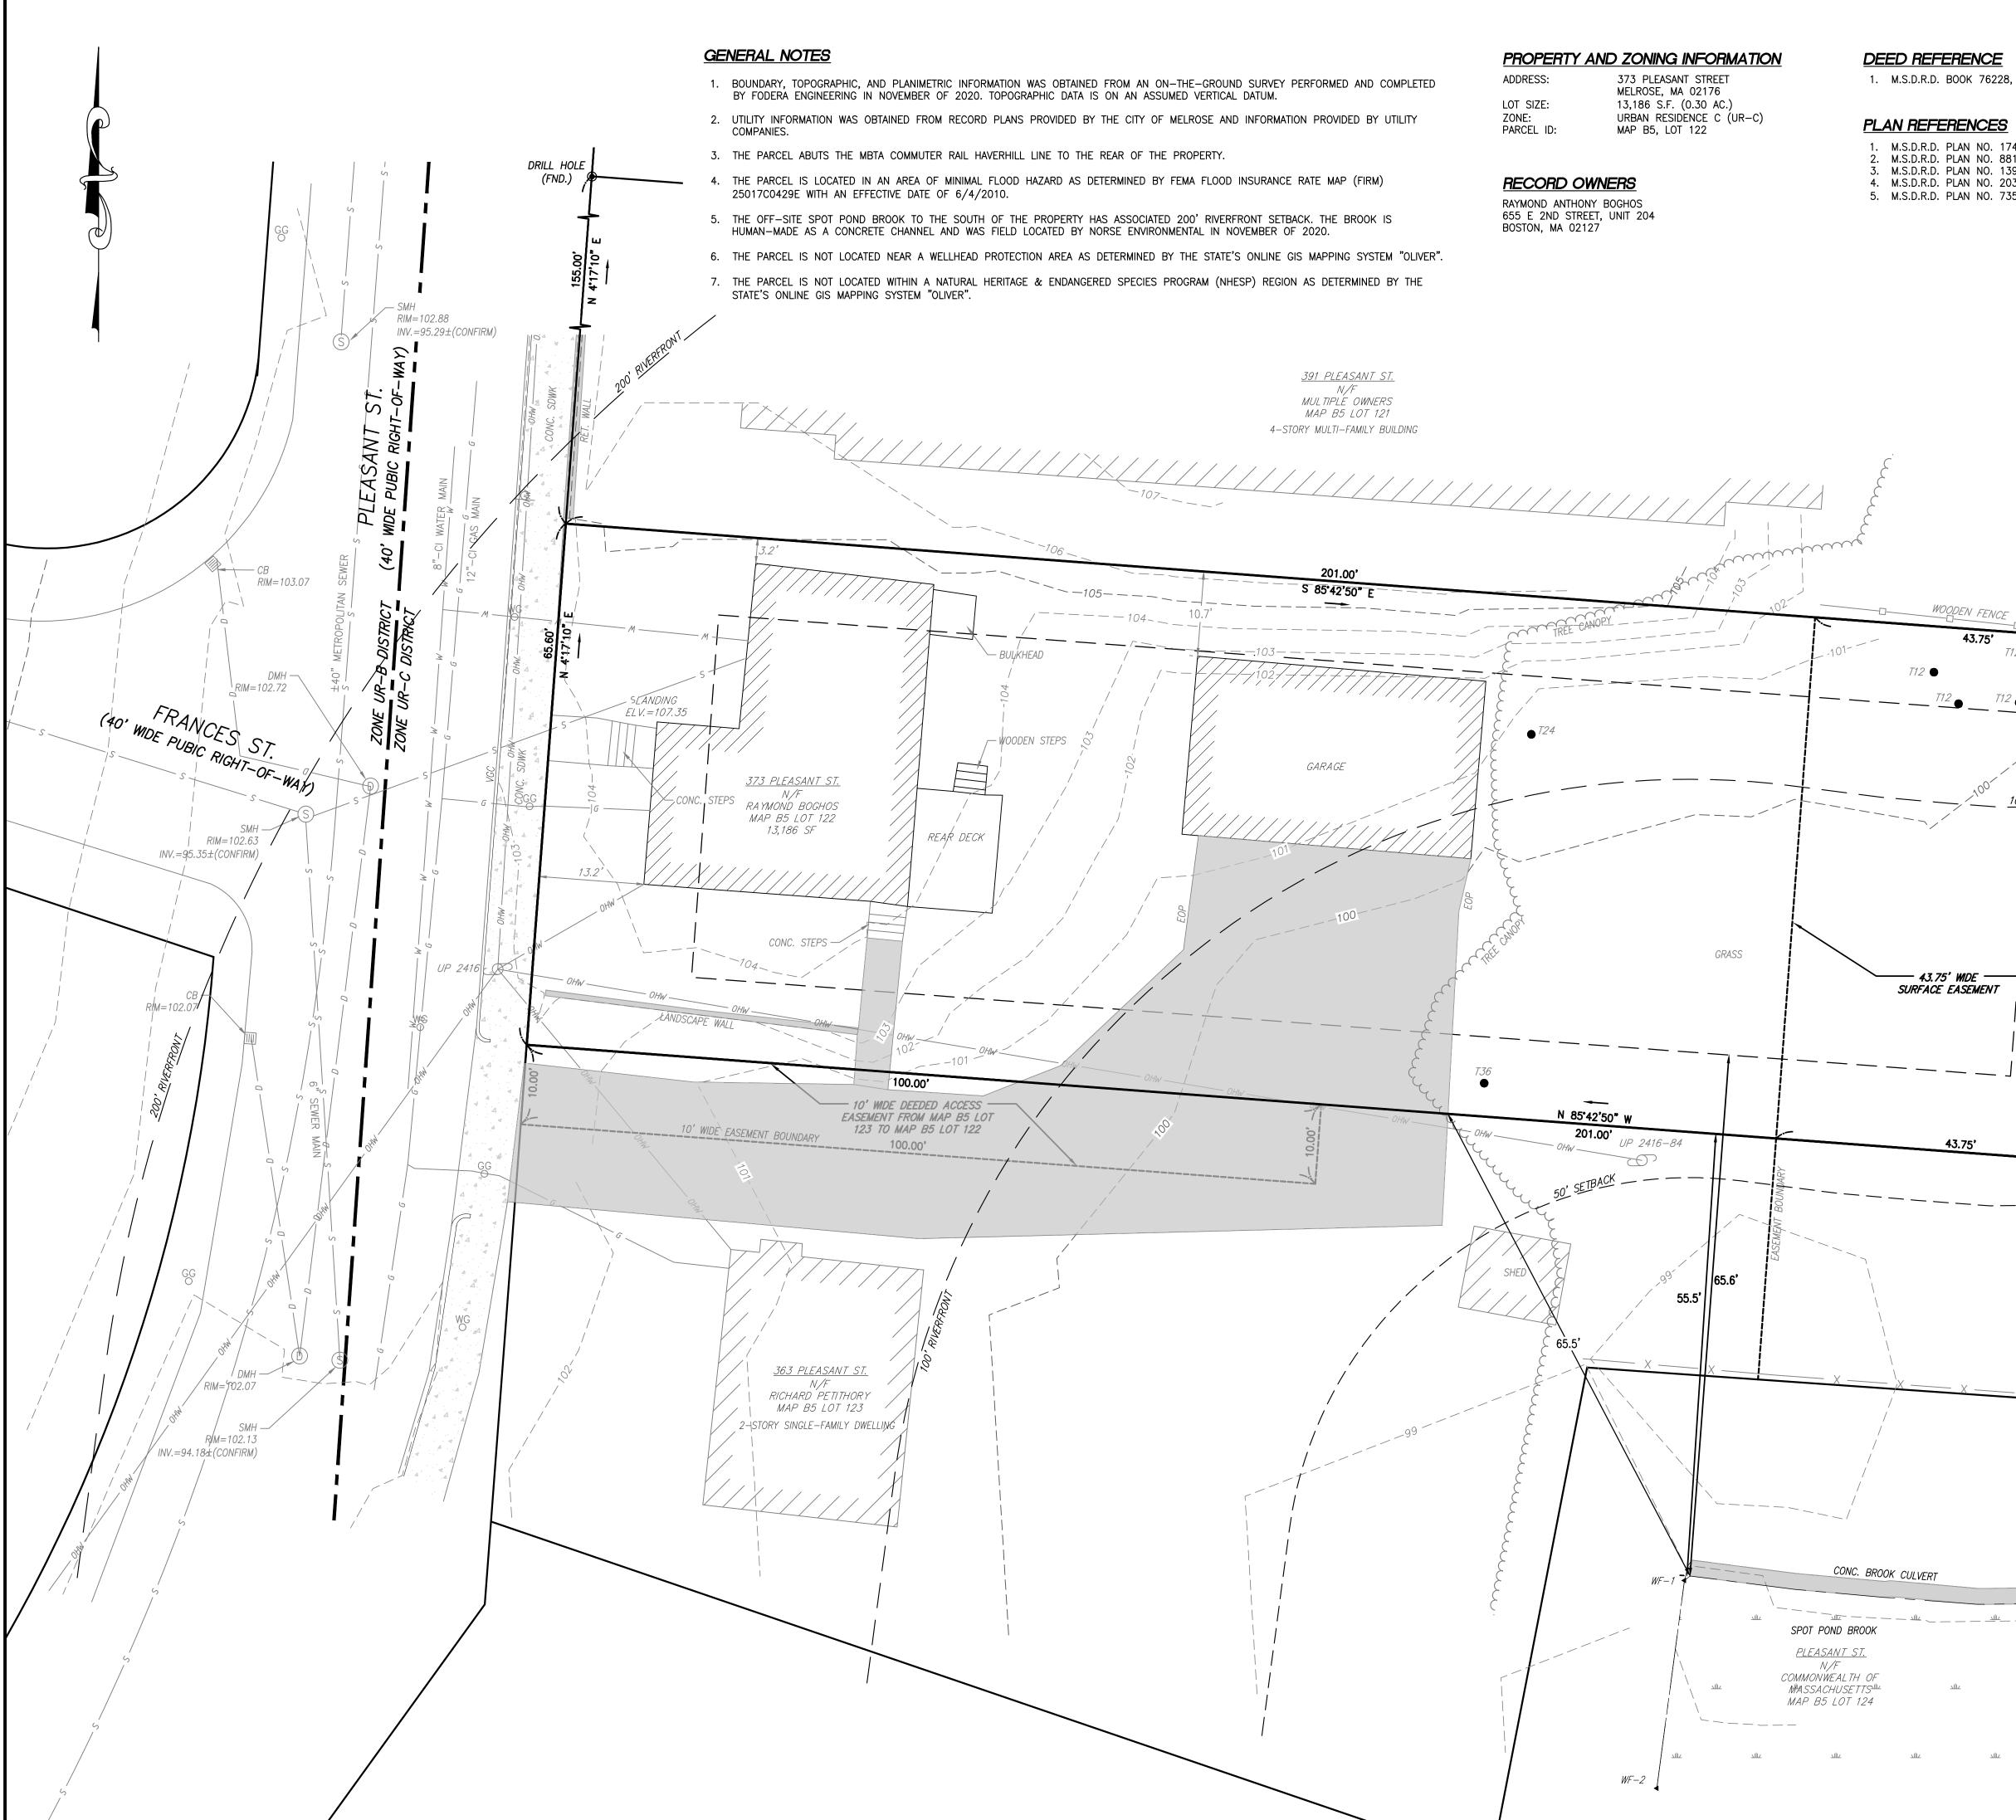

<u>PL/</u>	AN REFE	REN	ICE	<u>S</u>
1.	M.S.D.R.D.	PLAN	NO.	1748 OF 1959 (RECORD
2.	M.S.D.R.D.	PLAN	NO.	881 OF 1956
3.	M.S.D.R.D.	PLAN	NO.	1396 OF 1957
4.	M.S.D.R.D.	PLAN	NO.	203 OF 1960
5.	M.S.D.R.D.	PLAN	NO.	735 (1 of 6) OF 2007

43.75'


<u>100'</u>RI<u>VERFRONT</u>


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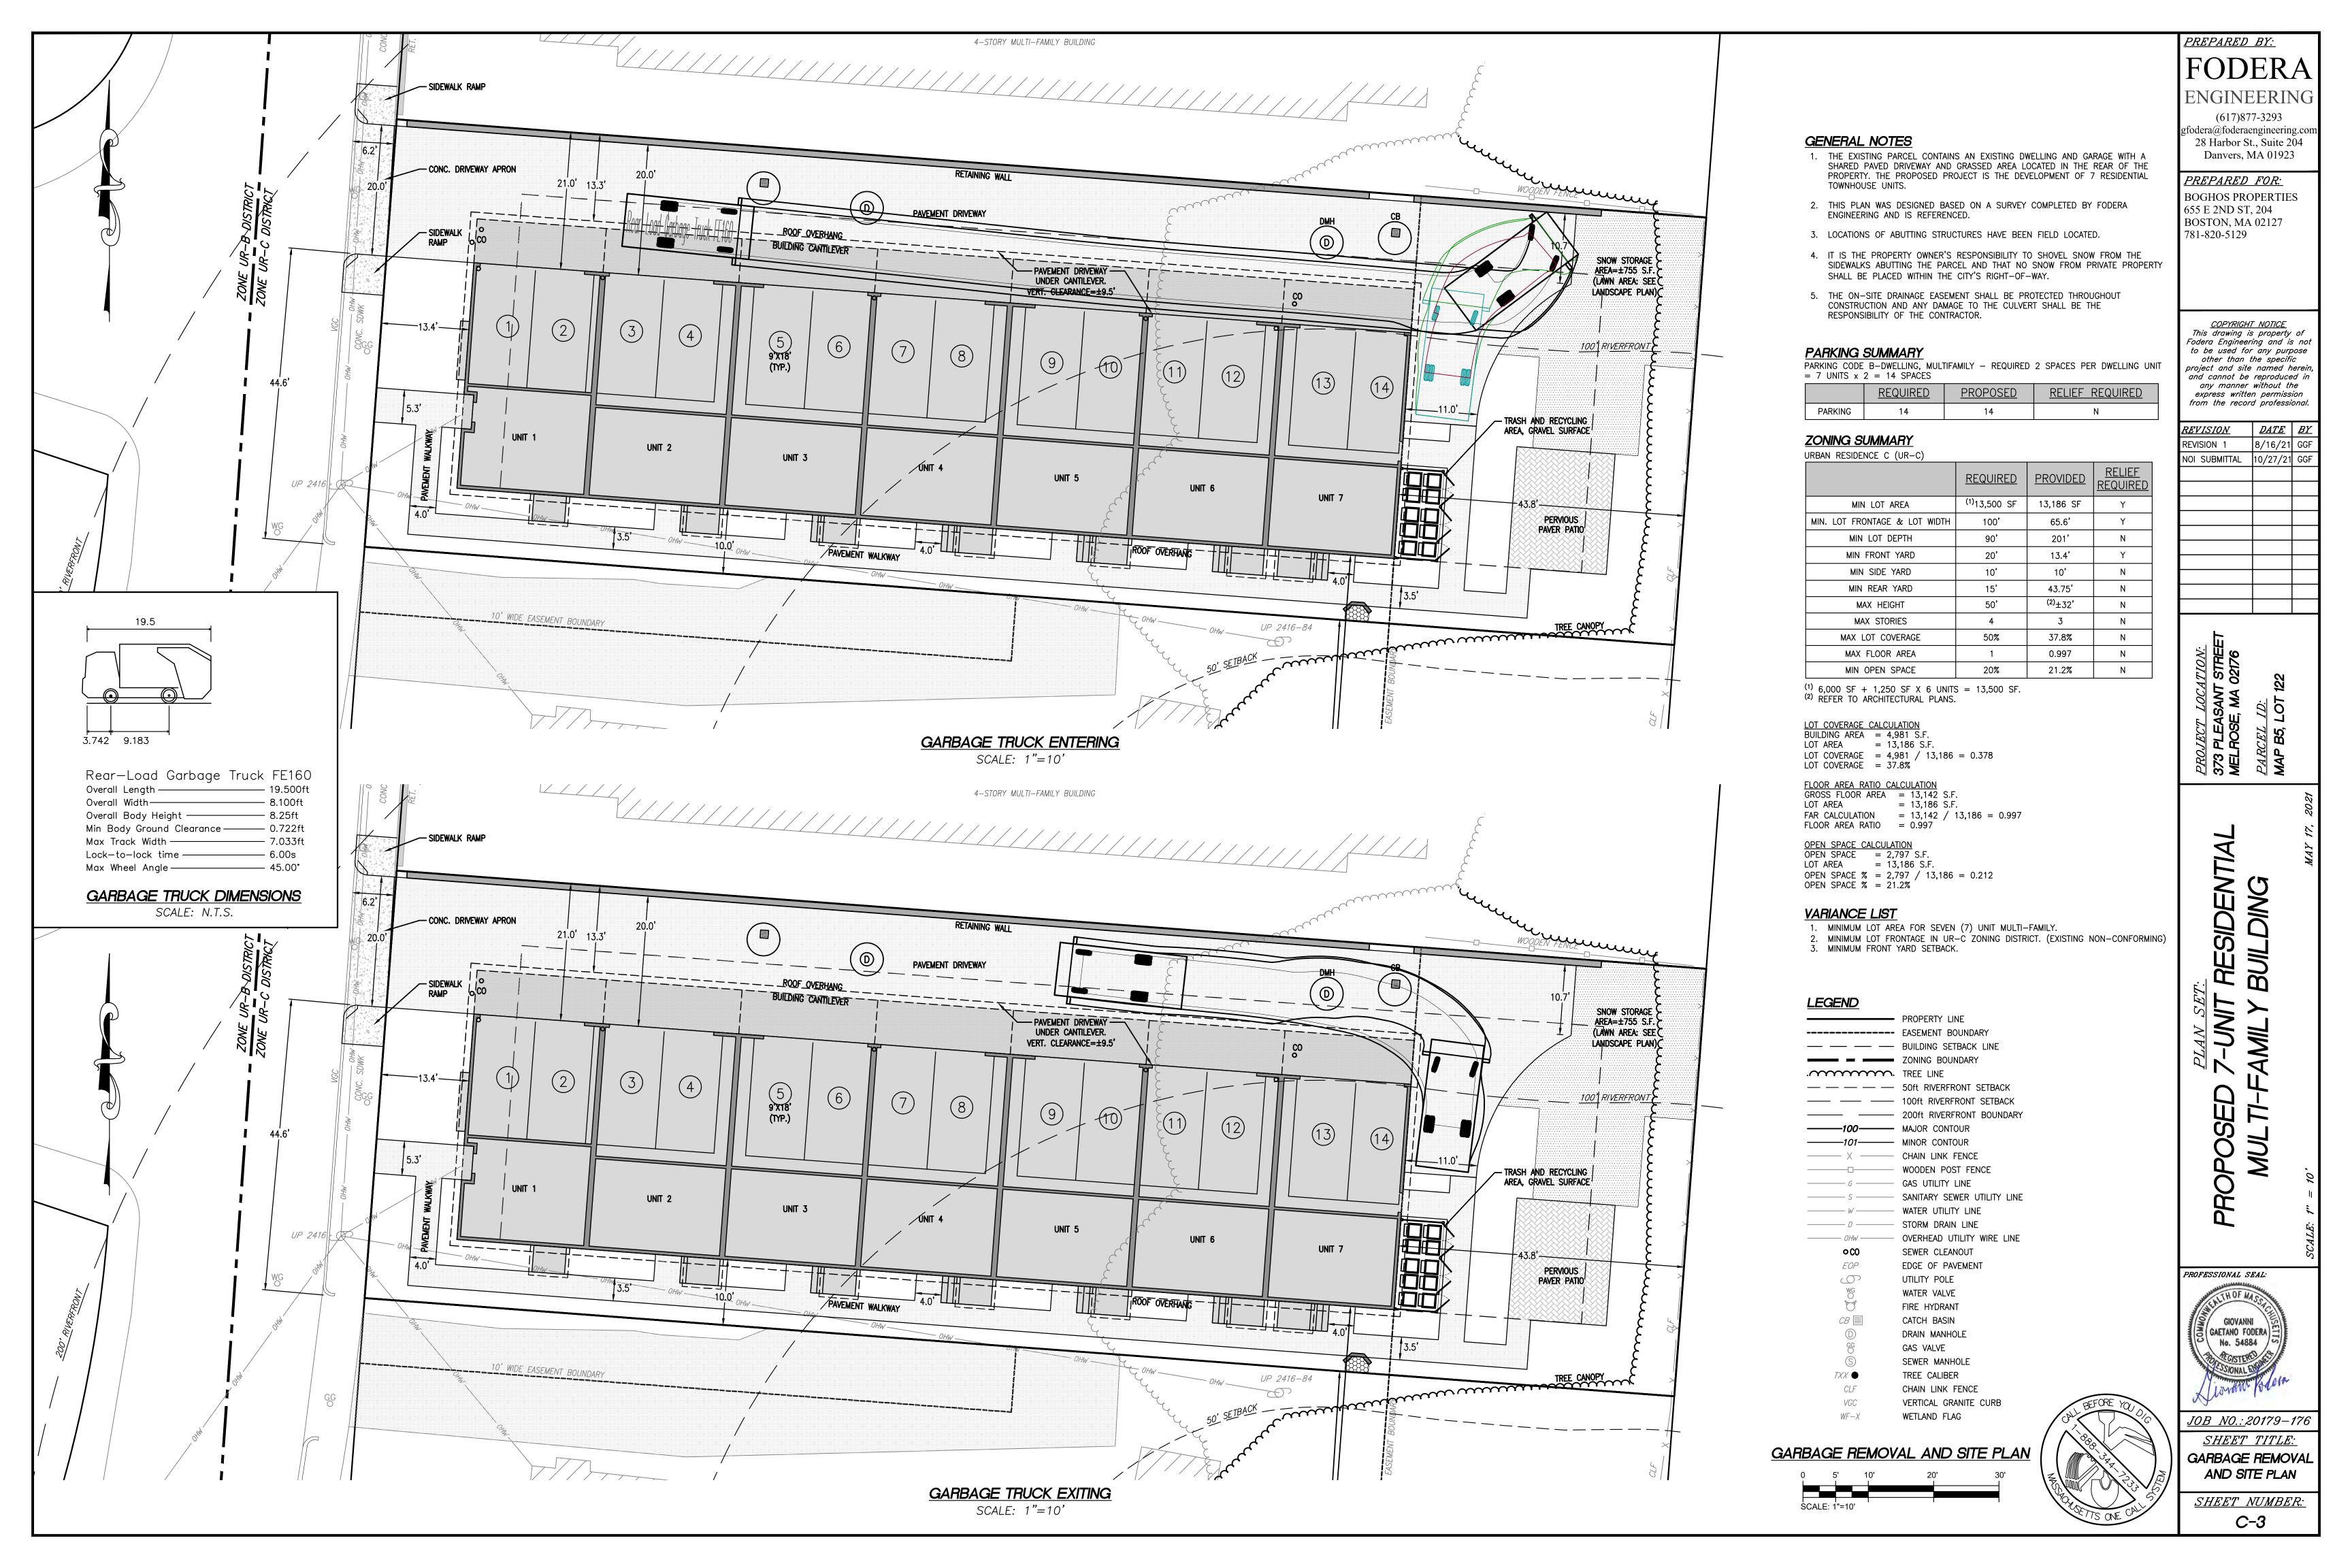
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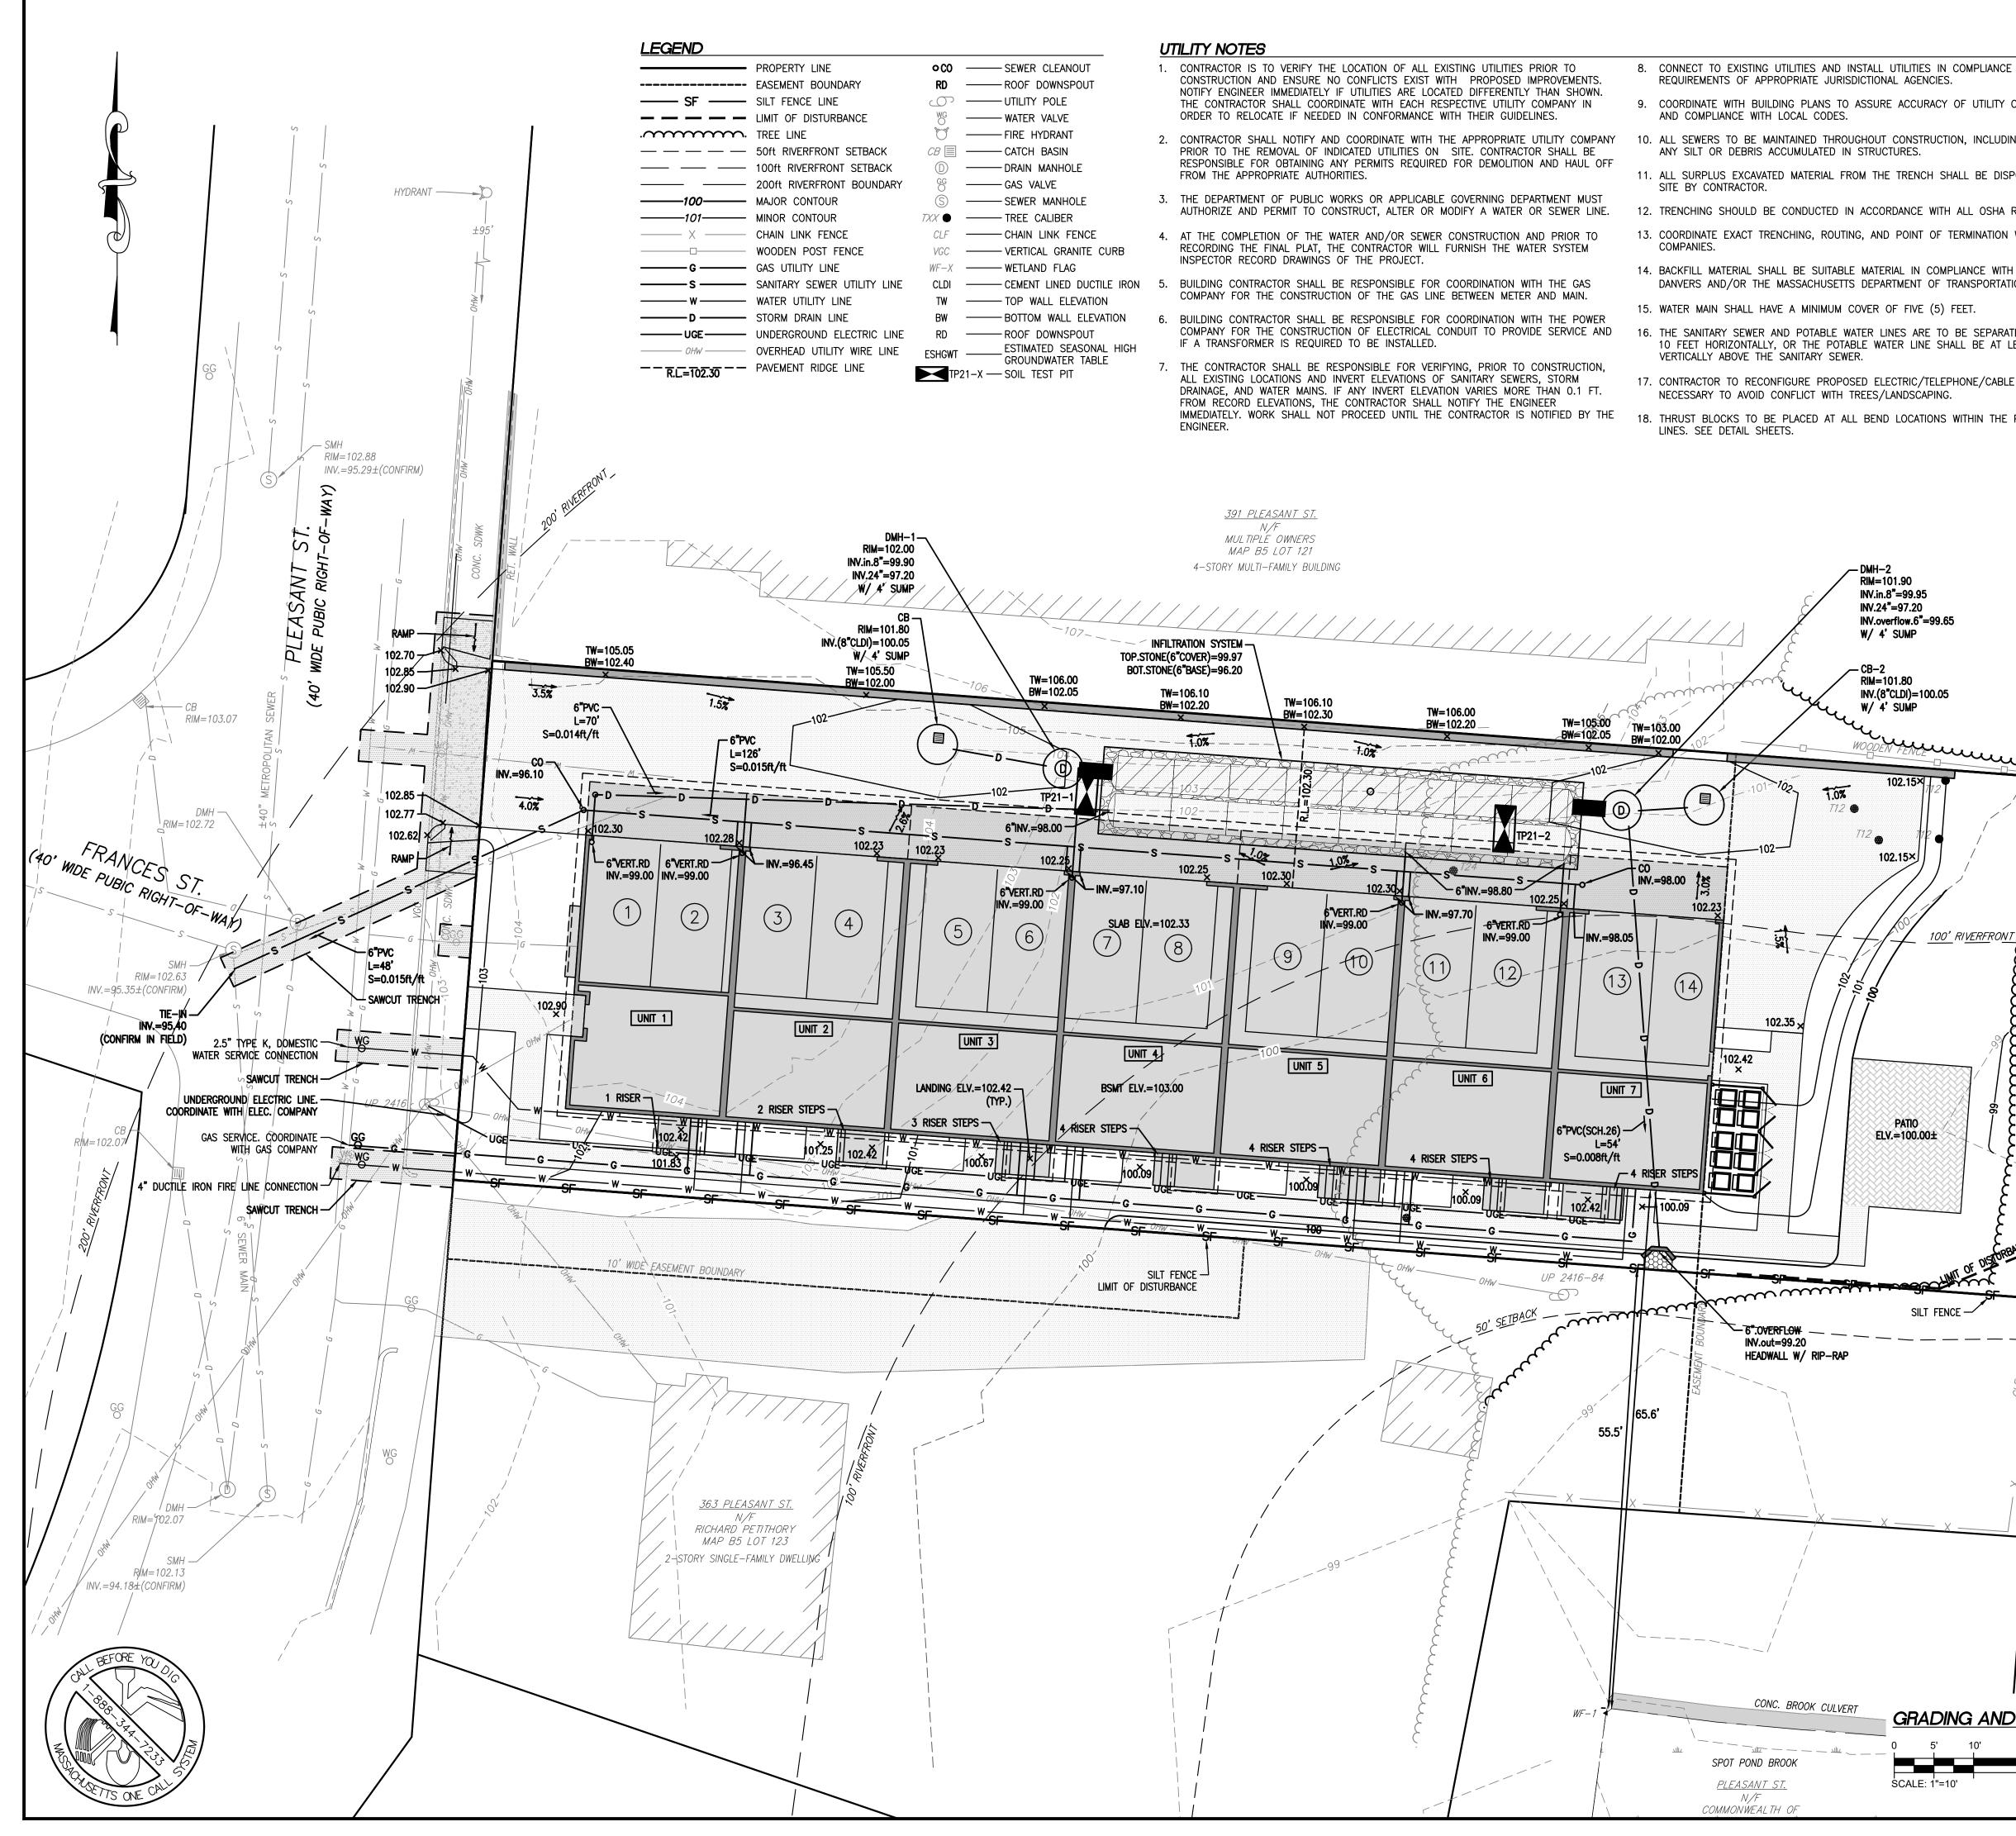
T12 🕤

1. M.S.D.R.D. BOOK 76228, PAGE 489





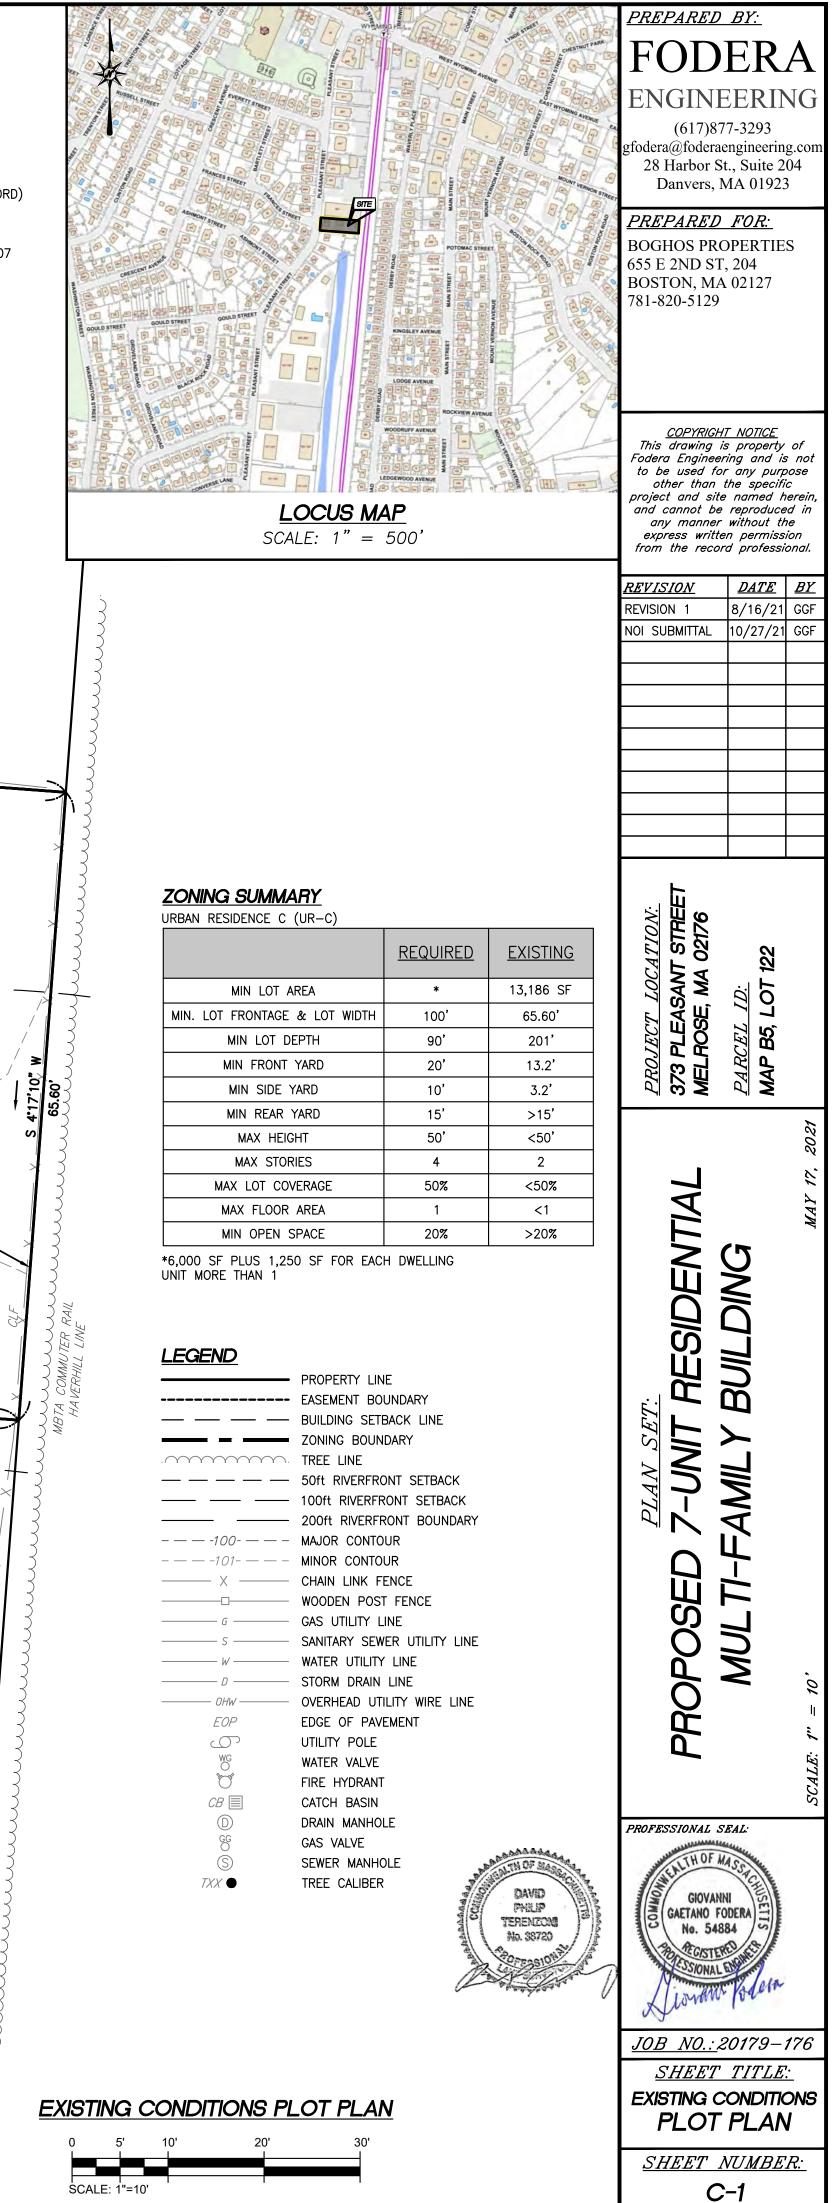

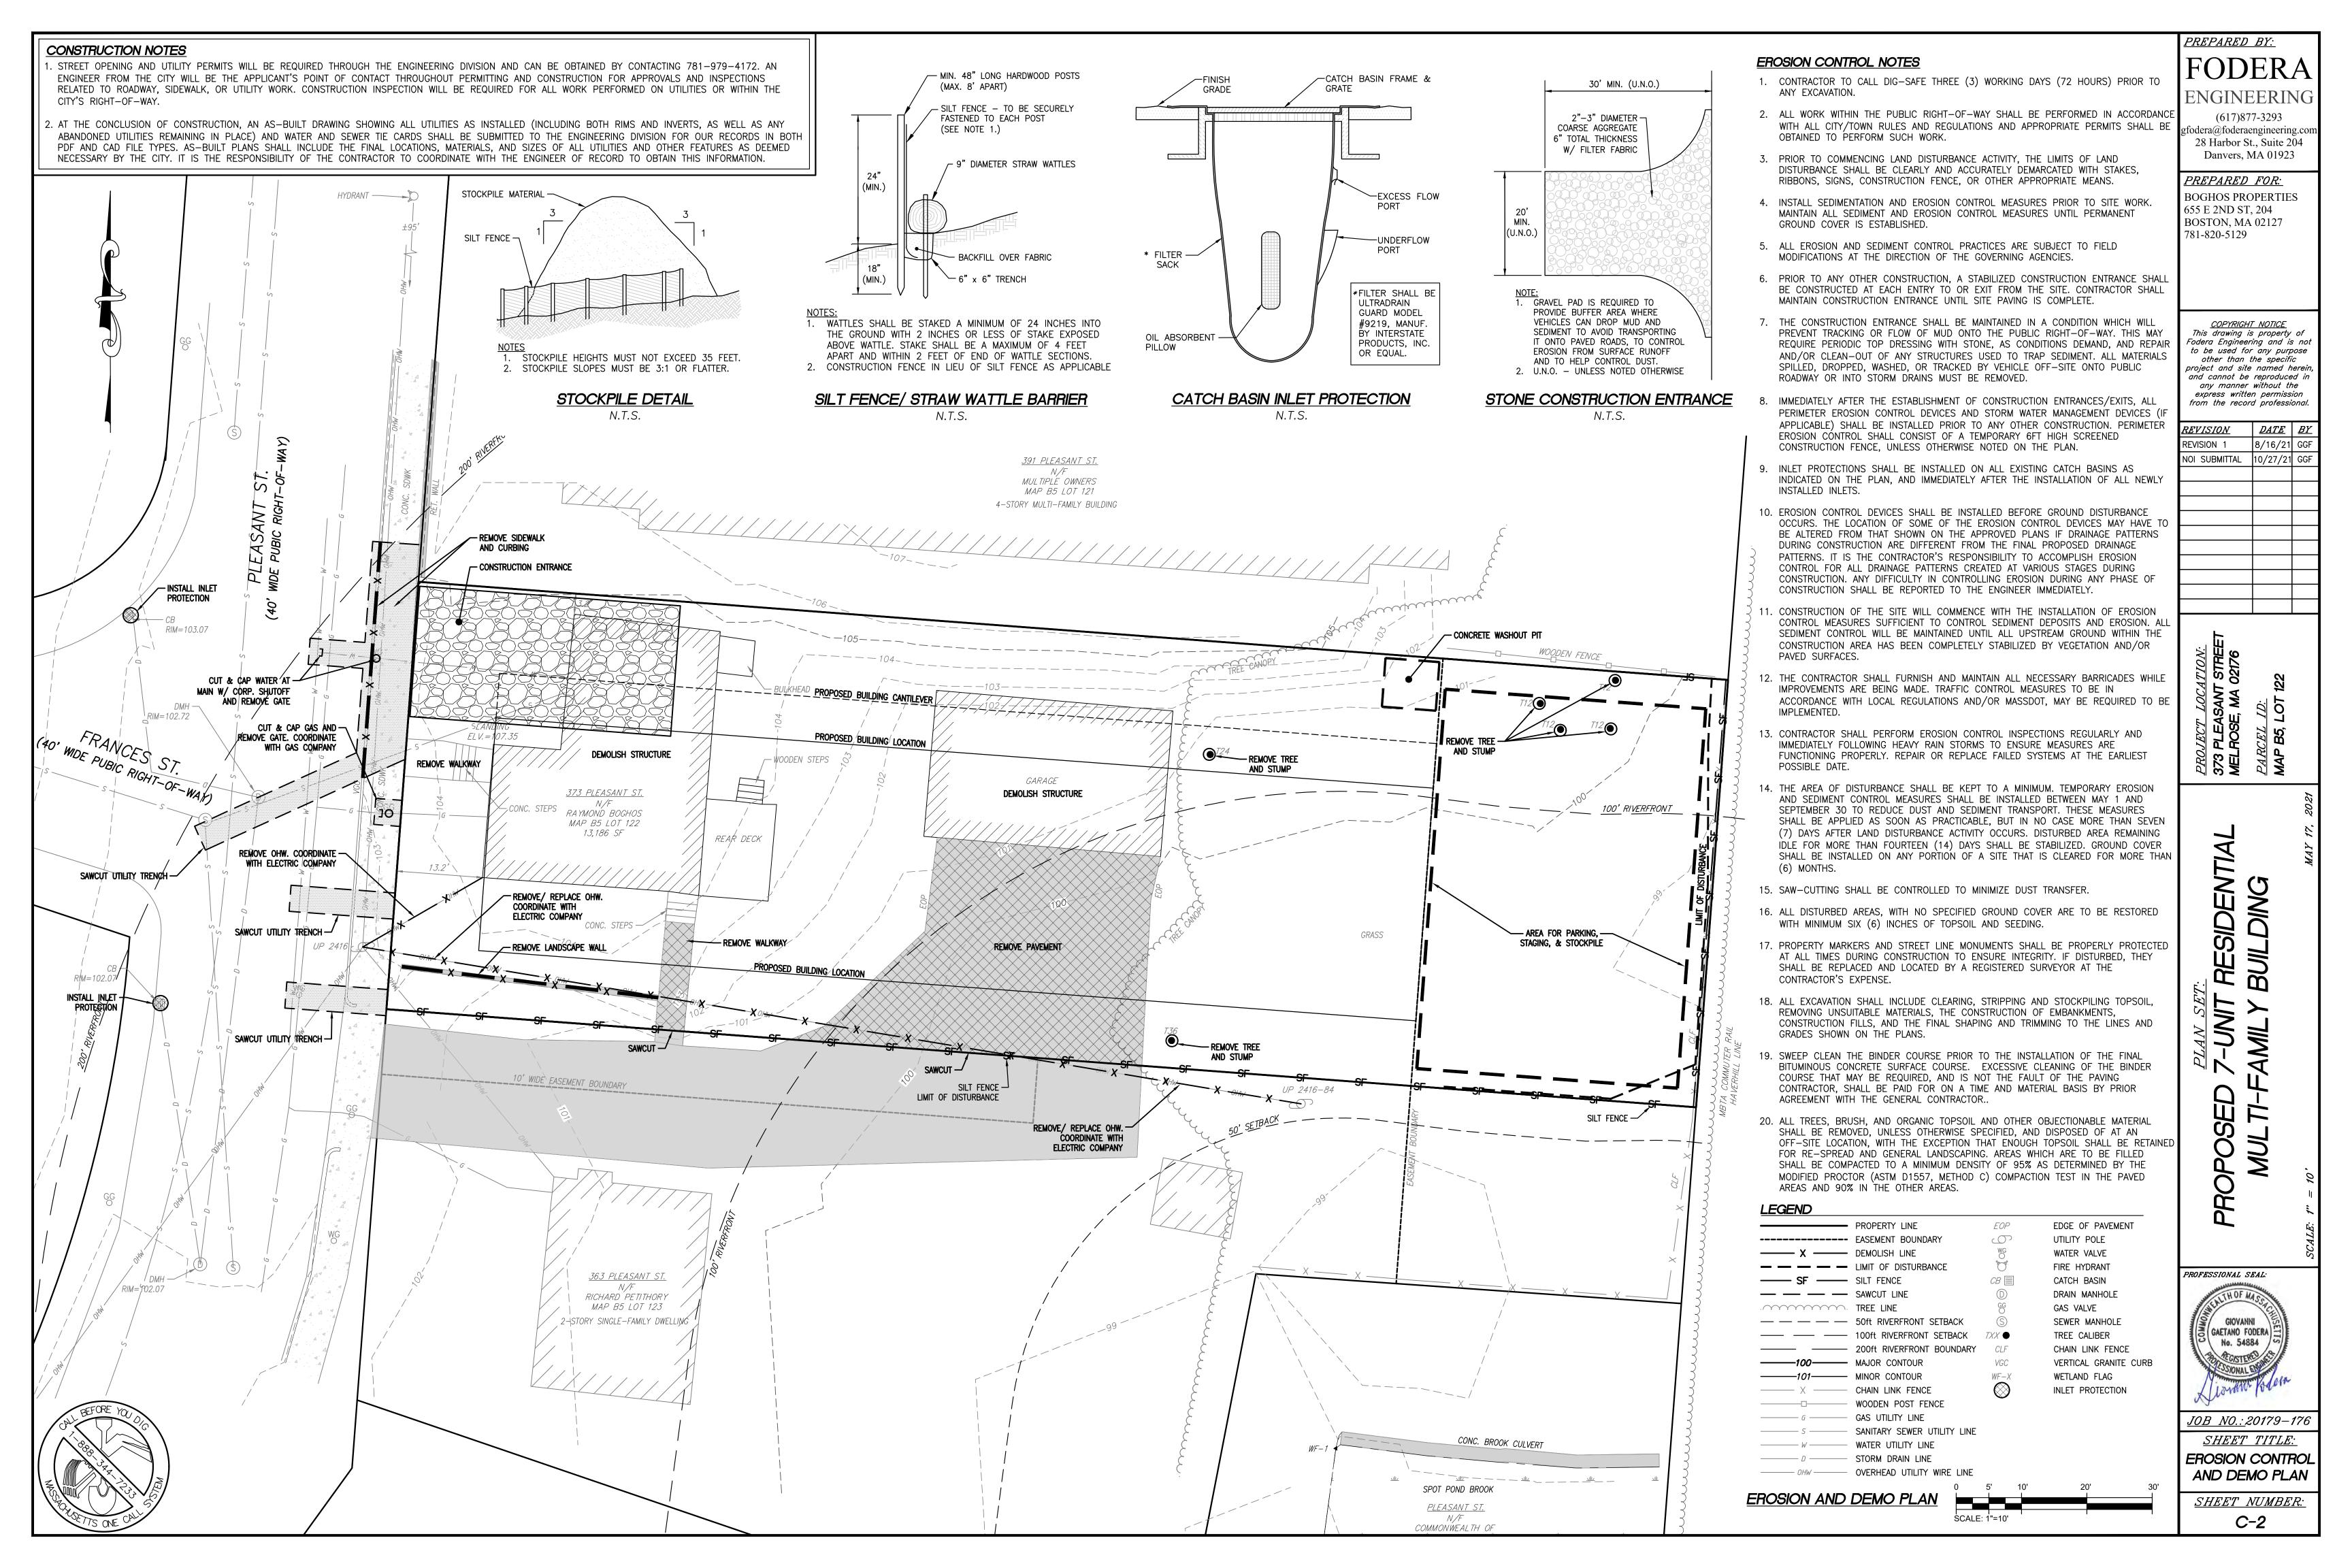


- DANVERS AND/OR THE MASSACHUSETTS DEPARTMENT OF TRANSPORTATI
- 10 FEET HORIZONTALLY, OR THE POTABLE WATER LINE SHALL BE AT LE


			<u>PREPARED</u>	BY:	
	GR	ADING AND DRAINAGE NOTES	FOD		A
E WITH		ALL CONSTRUCTION MATERIALS AND WORKMANSHIP SHALL BE IN ACCORDANCE TO THE TOWN'S LATEST CONSTRUCTION SPECIFICATIONS AND DETAILS.	ENGINE		
CONNECTIONS	2.	GRADING IN THE PUBLIC RIGHT-OF-WAY SHALL IN ACCORDANCE WITH LOCAL REGULATIONS, UNLESS OTHERWISE APPROVED BY THE TOWN.	(617)872 gfodera@foderae	ngineering	-
NG CLEANING OF	3.	THE CONTRACTOR SHALL NOTIFY DIG SAFE AND THE TOWN A MINIMUM OF 72 HOURS PRIOR TO THE START OF ANY EXCAVATIONS.	28 Harbor St. Danvers, N	*	
POSED OFF THE	4.	INSTALL ALL APPROPRIATE TREE PROTECTION MEASURES PRIOR TO GRADING AND EXCAVTION.	<u>PREPARED</u> BOGHOS PRO		S
REGULATIONS.	5.	EXACT LOCATIONS OF SAW-CUTTING MAY BE FIELD DETERMINED BASED ON EXISTING PAVEMENT CONDITIONS.	655 E 2ND ST, BOSTON, MA	204	J
WITH ALL UTILITY	6.	THE CONTRACTOR SHALL CAREFULLY PRESERVE BENCHMARKS, REFERENCE POINTS AND STAKES.	781-820-5129		
H THE TOWN OF TON (MASSDOT).		EROSION CONTROL MEASURES SHALL BE STABILIZED IN PLACE BEFORE BEGINNING SITE WORK. THESE MEASURES SHALL BE MAINTAINED THROUGHOUT CONSTRUCTION.			
TED BY AT LEAST LEAST 18 INCHES		ALL INDICATED ELEVATIONS ARE FINISHED ELEVATIONS. LOCATE AND PROTECT ALL UTILITIES ASSOCIATED WITH THE PROJECT PRIOR TO CONSTRUCTION.	<u>COPYRIGH1</u> This drawing is		of
E CONDUITS AS POTABLE WATER	10.	ALL EXCAVATION SHALL INCLUDE CLEARING, STRIPPING AND STOCKPILING TOPSOIL, REMOVING UNSUITABLE MATERIALS, THE CONSTRUCTION OF EMBANKMENTS, CONSTRUCTION FILLS, AND THE FINAL SHAPING AND TRIMMING TO THE LINES AND GRADES SHOWN ON THE PLANS.	Fodera Engineeri to be used for other than t project and site and cannot be any manner	ing and is any purp he specific named he reproduced	not ose c erein, d in
	11.	ALL TREES, BRUSH, AND ORGANIC TOPSOIL AND OTHER OBJECTIONABLE MATERIAL SHALL BE REMOVED, UNLESS OTHERWISE SPECIFIED, AND DISPOSED OF AT AN OFF-SITE LOCATION, WITH THE EXCEPTION THAT ENOUGH TOPSOIL SHALL BE RETAINED FOR	express written from the record	n permissi	on
		RE-SPREAD AND GENERAL LANDSCAPING. AREAS WHICH ARE TO BE FILLED SHALL BE COMPACTED TO A MINIMUM DENSITY OF 95% AS DETERMINED BY THE MODIFIED PROCTOR (ASTM D1557, METHOD C) COMPACTION TEST IN THE PAVED AREAS AND 90% IN THE OTHER AREAS.		<i>DATE</i> 8/16/21 10/27/21	GGF
	12.	CONTRACTOR SHALL PROVIDE POSITIVE DRAINAGE TO ALL INLETS AND CATCH BASINS. AREAS OF SURFACE PONDING SHALL BE CORRECTED BY CONTRACTOR AT NO ADDITIONAL EXPENSE TO THE OWNER.			
	13.	IF AREAS ARE DISTURBED BEYOND PROPOSED GRADES BY NEGLIGENCE OF THE CONTRACTOR, THE CONTRACTOR SHALL BE HELD RESPONSIBLE FOR ANY REGRADING OR REPAIR TO MATCH ORIGINAL EXISTING CONDITIONS.			
	14.	SHORING SHALL BE DONE AS NECESSARY FOR THE PROTECTION OF THE WORK AND FOR THE SAFETY OF PERSONNEL. SHORING SHALL BE IN ACCORDANCE WITH ALL O.S.H.A AND LOCAL REGULATIONS.			
	15.	CONTRACTOR SHALL ADJUST GRADES BY VARYING THE PAVEMENT SECTIONS ACCORDINGLY. EXISTING COMPACTED SUBGRADE TO BE DISTURBED AS LITTLE AS POSSIBLE.			
	16.	ALL PROPOSED SPOT ELEVATIONS SHOWN INDICATE FINISHED GRADED ELEVATIONS AT EDGE OF PAVEMENT AND/OR GRADE BREAKS, UNLESS OTHERWISE NOTED.	. Lī		
	17.	MAINTAIN PROPER SITE DRAINAGE AT ALL TIMES DURING THE COURSE OF CONSTRUCTION, AND PREVENT STORM WATER FROM RUNNING INTO OR STANDING IN EXCAVATED AREAS.	<u>4 T.ION:</u> r STREET 02176	•	
	18.	SPREAD AND COMPACT UNIFORMLY TO THE DEGREE SPECIFIED ALL EXCESS TRENCH SPOIL AFTER COMPLETION OF THE UNDERGROUND IMPROVEMENTS (EARTHWORK CONTRACTOR SHALL MAKE APPROPRIATE ADJUSTMENTS IN ROUGH GRADING TO ACCOMMODATE TRENCH SPOIL).	LOC. SANT	<u>ID:</u> LOT 122	
ξ 3	19.	PROVIDE WATER TO ADD TO DRY MATERIAL IN ORDER TO ADJUST THE MOISTURE CONTENT FOR THE PURPOSE OF ACHIEVING THE SPECIFIED COMPACTION.	PROJECT 373 PLEA VELROSE	<u>PARCEL</u> MAP B5, L	
	20.	UNSUITABLE MATERIAL SHALL BE CONSIDERED AS MATERIAL WHICH IS NOT SUITABLE FOR THE SUPPORT OF PAVEMENT AND BUILDING CONSTRUCTION, AND IS ENCOUNTERED BELOW NORMAL TOPSOIL DEPTHS AND THE PROPOSED SUB-GRADE ELEVATION. THE DECISION TO REMOVE SAID MATERIAL, AND TO WHAT EXTENT, SHALL BE MADE BY A SOILS ENGINEER WITH THE CONCURRENCE OF THE OWNER.	<u>PR(</u> 373 MEI	<u>PAF</u> MAF	2021
	21.	REPAIR ANY BASE COURSE AND BINDER COURSE FAILURES PRIOR TO THE INSTALLATION OF THE FINAL BITUMINOUS CONCRETE SURFACE COURSE.			17, 20
	22.	SWEEP CLEAN THE BINDER COURSE PRIOR TO THE INSTALLATION OF THE FINAL BITUMINOUS CONCRETE SURFACE COURSE. EXCESSIVE CLEANING OF THE BINDER COURSE THAT MAY BE REQUIRED, AND IS NOT THE FAULT OF THE PAVING CONTRACTOR, SHALL BE PAID FOR ON A TIME AND MATERIAL BASIS BY PRIOR AGREEMENT WITH THE GENERAL	DENTIA	7	MAY
	23.	CONTRACTOR. CONFIRM INVERTS OF ALL EXISTING STORM INLETS AND SANITARY SEWER MANHOLES BEFORE COMMENCING CONSTRUCTION.	ШC		
	24.	ALL STORM SEWER LINES $18"-54"$ DIAMETER ARE TO BE REINFORCED CONCRETE PIPE ACCORDING TO ASTM C-76 TYPE III, UNLESS OTHERWISE SPECIFIED ON PLANS.			
	25.	A GEOTEXTILE MATTING (LANDLOCK TRM 450 OR EQUIVALENT) SHALL BE USED FOR EROSION CONTROL AN ALL SLOPES GREATER THAN 3H:1V IF NECESSARY.		5	
	26.	DRAINAGE STRUCTURES AND UNDERGROUND INFILTRATION FACILITIES SHALL BE INSPECTED SEMIANNUALLY TO ENSURE PROPER WORKING ORDER.		۲ ۲	
QLF UUUU RAIL E	27.	UNSUITABLE EXISTING SOILS, SILT, AND DEBRIS SHALL BE ADEQUATELY REMOVED FROM THE AREA OF THE PROPOSED INFILTRATION BASIN. REMOVE ALL ORGANICS.			
MBTA COMMUTER HAVERHILL LIN	28.	IF THE CONTRACTOR IN THE COURSE OF WORK FINDS ANY DISCREPANCIES BETWEEN THE PLANS AND THE PHYSICAL CONDITIONS OF THE LOCALITY, OR ANY ERRORS OR OMISSIONS IN THE PLANS OR IN THE LAYOUT AS GIVEN BY THE ENGINEER, IT SHALL BE HIS DUTY TO IMMEDIATELY INFORM THE ENGINEER, IN WRITING AND THE ENGINEER WILL PROMPTLY VERIFY THE SAME. ANY WORK DONE AFTER SUCH A DISCOVERY, UNTIL AUTHORIZED, WILL		-FAN	
MB	29.	BE AT THE CONTRACTOR'S RISK. ALL WORK WITHIN THE RIGHT-OF-WAY SHALL BE PERFORMED IN ACCORDANCE AND UP TO CITY STANDARDS FOR BOTH ROADWAY AND SIDEWALKS.)SE		
		SOIL TEST RESULTS		JK M	,01
- X - CLF		TEST_DATE: 7/23/2021 <u>WEATHER:</u> 75°F, SUNNY, DRY, & HUMID <u>SOIL_EVALUATOR:</u> ALEXANDER_PARKER <u>LICENCE #:</u> 1848	PRO		CALE: 1" = 10
		$\frac{\text{TP21}-1}{\text{ELV. DPTH. Soil Data}} \xrightarrow{\text{TP21}-2}$ $\frac{102.5 \times 0^{n}-10^{n}}{102 \times 10^{n}} \xrightarrow{\text{A}_{P}(0^{n}-16^{n})}$	PROFESSIONAL SE	7.4 J.•	SCAL
		$\begin{array}{c ccccccccccccccccccccccccccccccccccc$	MAN THON MAN	SSTCP	
		99 - 98 - 98 - 2C (21"-120") 98 - 98 - 99 - 22"- 10YR 3/2 Bw (22"-28") Sandy Loam Bw (22"-28") Sandy Loam	GIOVANN GAETANO FOI No. 5488	DERA 3	
		97 - Sand 97 - 10YR 5/8 5Y 5/2 96 - 2C (28"-120") Sand 5Y 5/2 - 5Y 5/2	THOUSE CISTER	S dem	
		95	Alloward a		170
		92.5 - 120"	<u>JOB_NO.:</u> 2 <u>SHEET</u>		
	⊻ 30' ⊣	ESHGWT ELV.=94.2 WEEPING ELV.=93.7 WEEPING ELV.=93.7 NO REFUSAL ESHGWT ELV.=93.6 WEEPING ELV.=93.1	GRADIN UTILITY		
		WLEFING ELV.=9J.1	<u>SHEET N</u>		

C-4



une	P - Passenger Car Overall Length 17.000ft Overall Width 6.000ft Overall Body Height 4.300ft Min Body Ground Clearance 1.115ft Track Width 6.000ft Lock-to-lock time 4.00s Max Steering Angle (Virtual) 31.60*	PREPARED BY: FODERA ENGINEERING (617)877-3293 gfodera@foderaengineering.com 28 Harbor St., Suite 204 Danvers, MA 01923 PREPARED FOR: BOGHOS PROPERTIES 655 E 2ND ST, 204 BOSTON, MA 02127 781-820-5129
		COPYRIGHT NOTICEThis drawing is property ofFodera Engineering and is notto be used for any purposeother than the specificproject and site named herein,and cannot be reproduced inany manner without theexpress written permissionfrom the record professional.REVISIONDATEBYREVISION 18/16/21GGFNOI SUBMITTAL10/27/21GGFImage: specific or spe
TA VERHILL LINE	VEHICLE SIMULATION 0 5' 10' 20' 30' Definition of the second se	PROJECT LOCATION: 373 PLEASANT STREET 373 PLEASANT STREET MELROSE, MA 02176 PARCEL ID: MAP B5, LOT 122
mu	17 Image: Car overall Length 17.000ft Overall Width 6.000ft Overall Body Height 4.300ft Min Body Ground Clearance 1.115ft Track Width Lock-to-lock time Max Steering Angle (Virtual) 31.60*	PLAN SET: 7-UNIT RESIDENTIAL AMLY BUILDING AMLY BUILDING
		PROFESSIONAL SEAL:
A COMMUTER RAIL FA VERHILL LINE	VEHICLE SIMULATION 0 5 10' 20' 30' DELE: 1"=10'	GAETANO FODERA No. 54884 <u>FORSTEROSE</u> <u>JOB NO.: 20179–176</u> <u>SHEET TITLE:</u> VEHICLE SIMULATION <u>SHEET NUMBER:</u> C-5

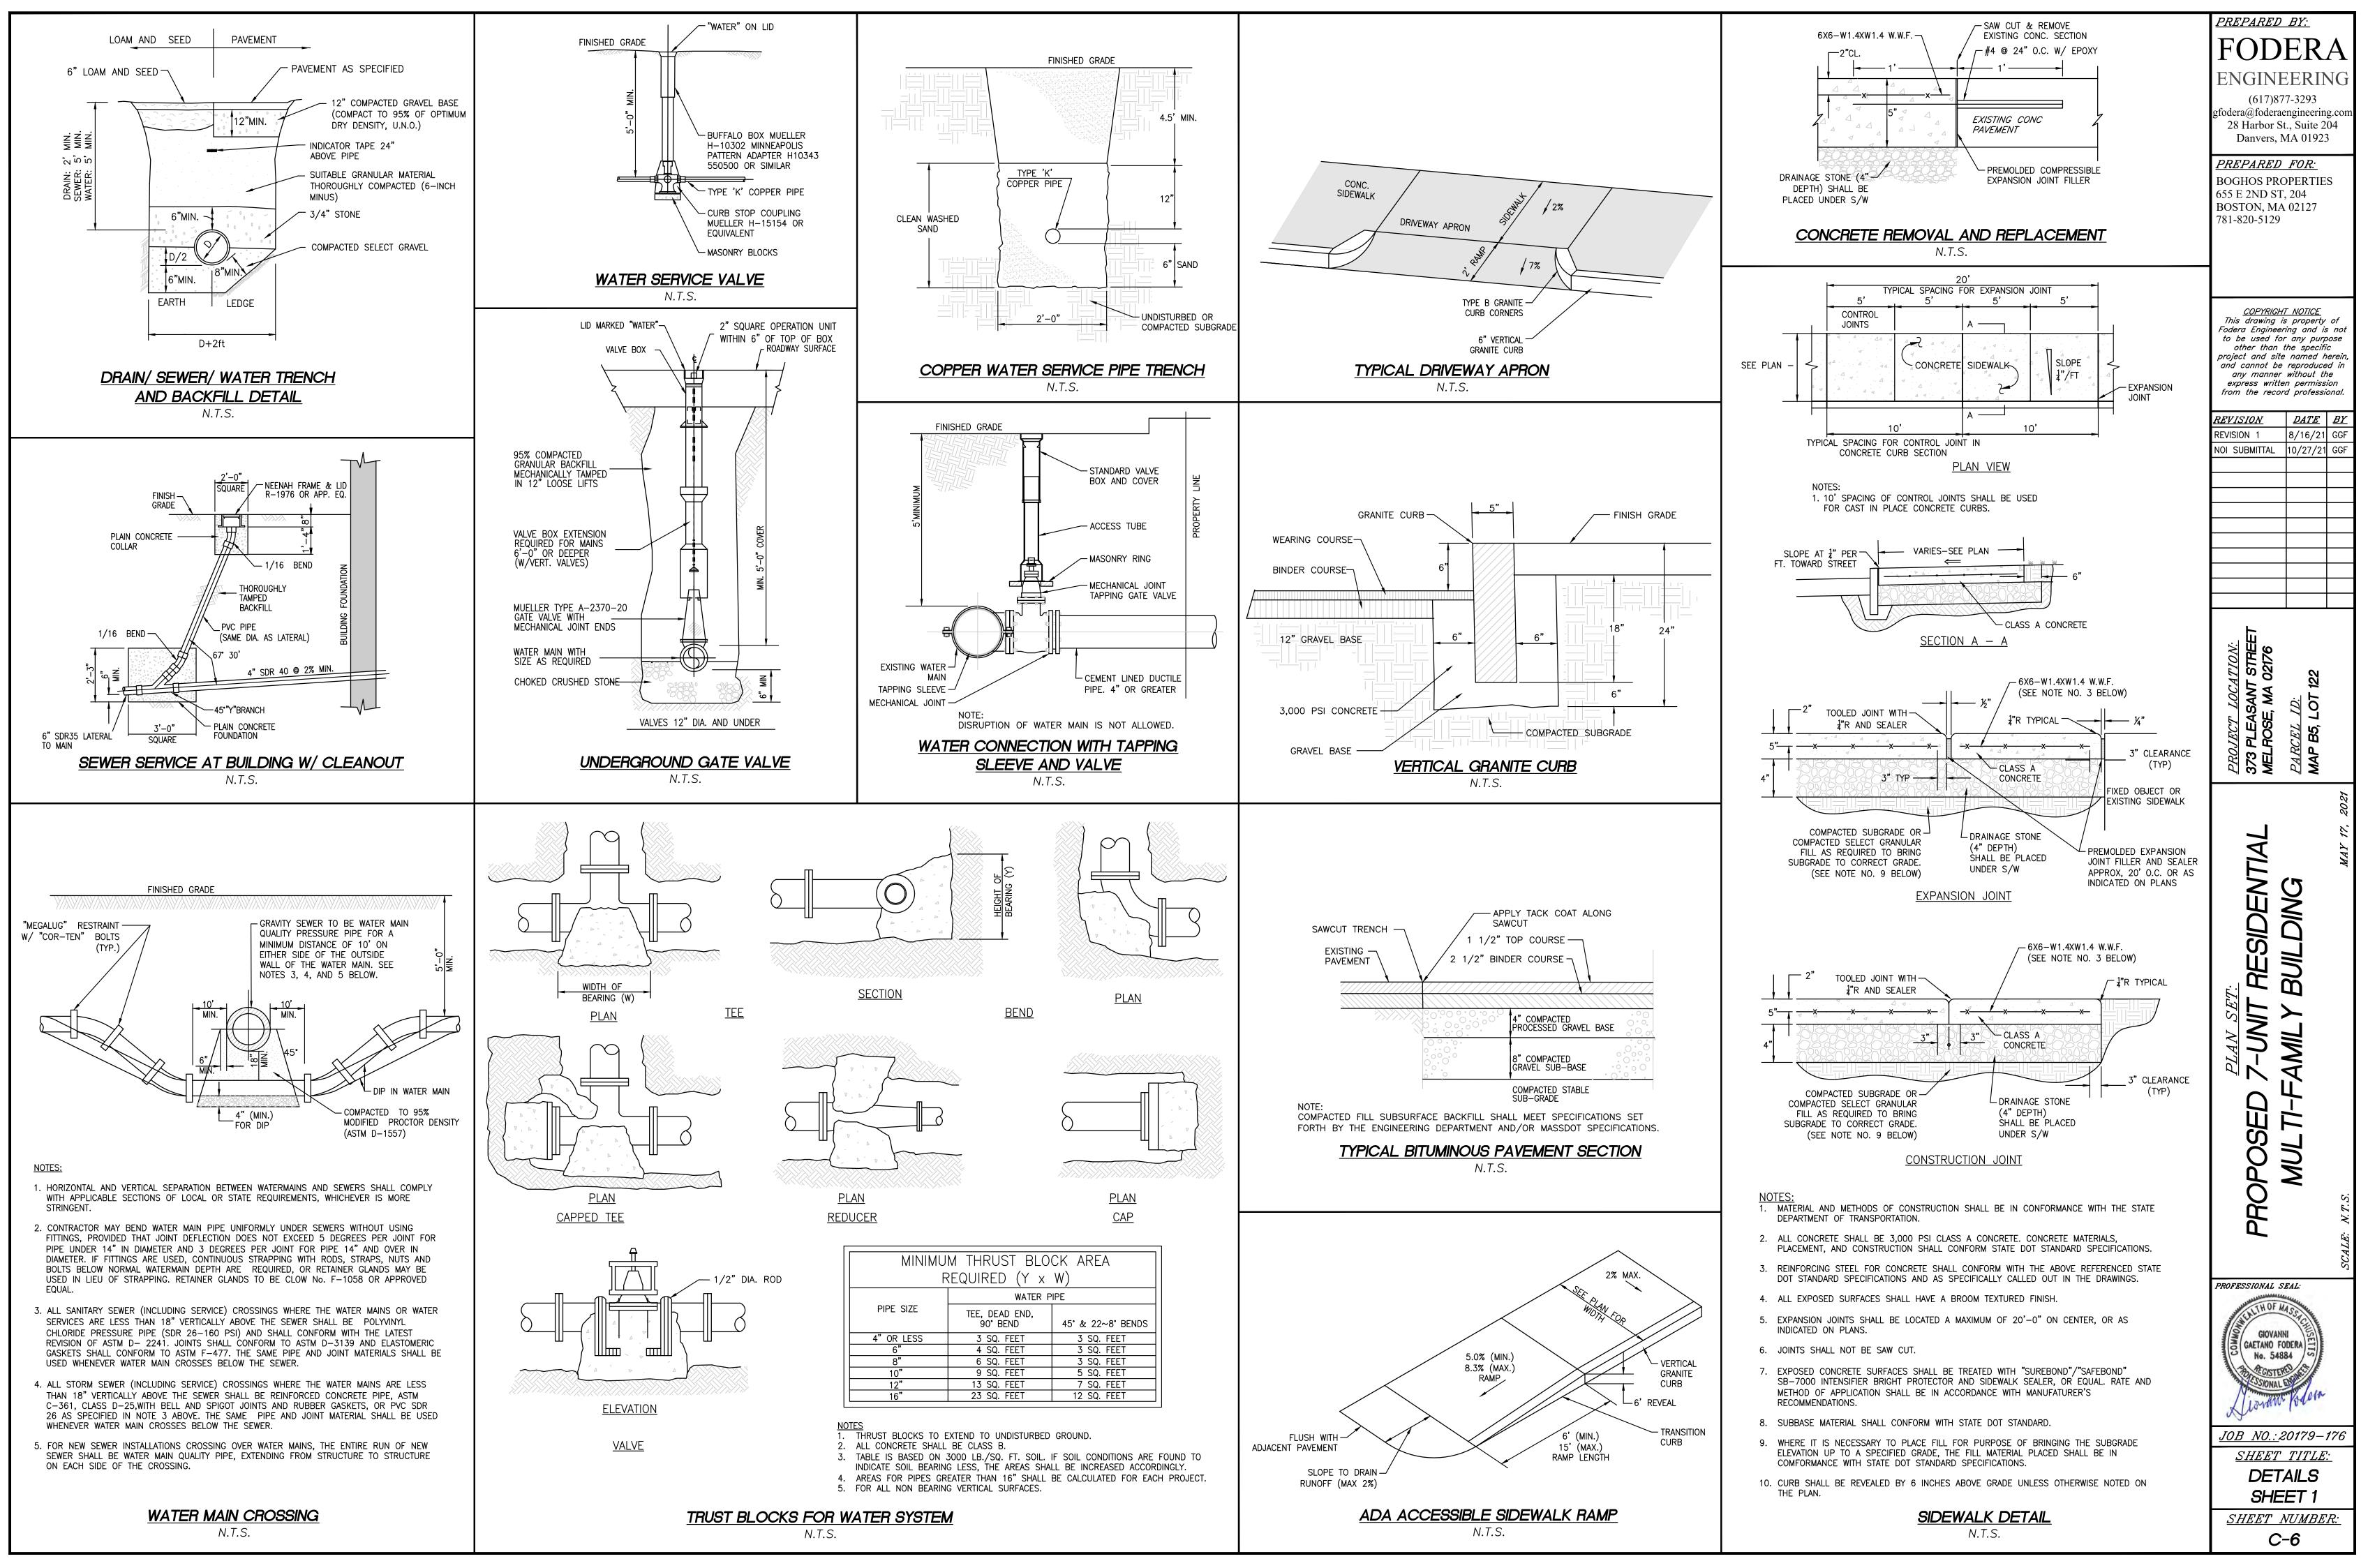

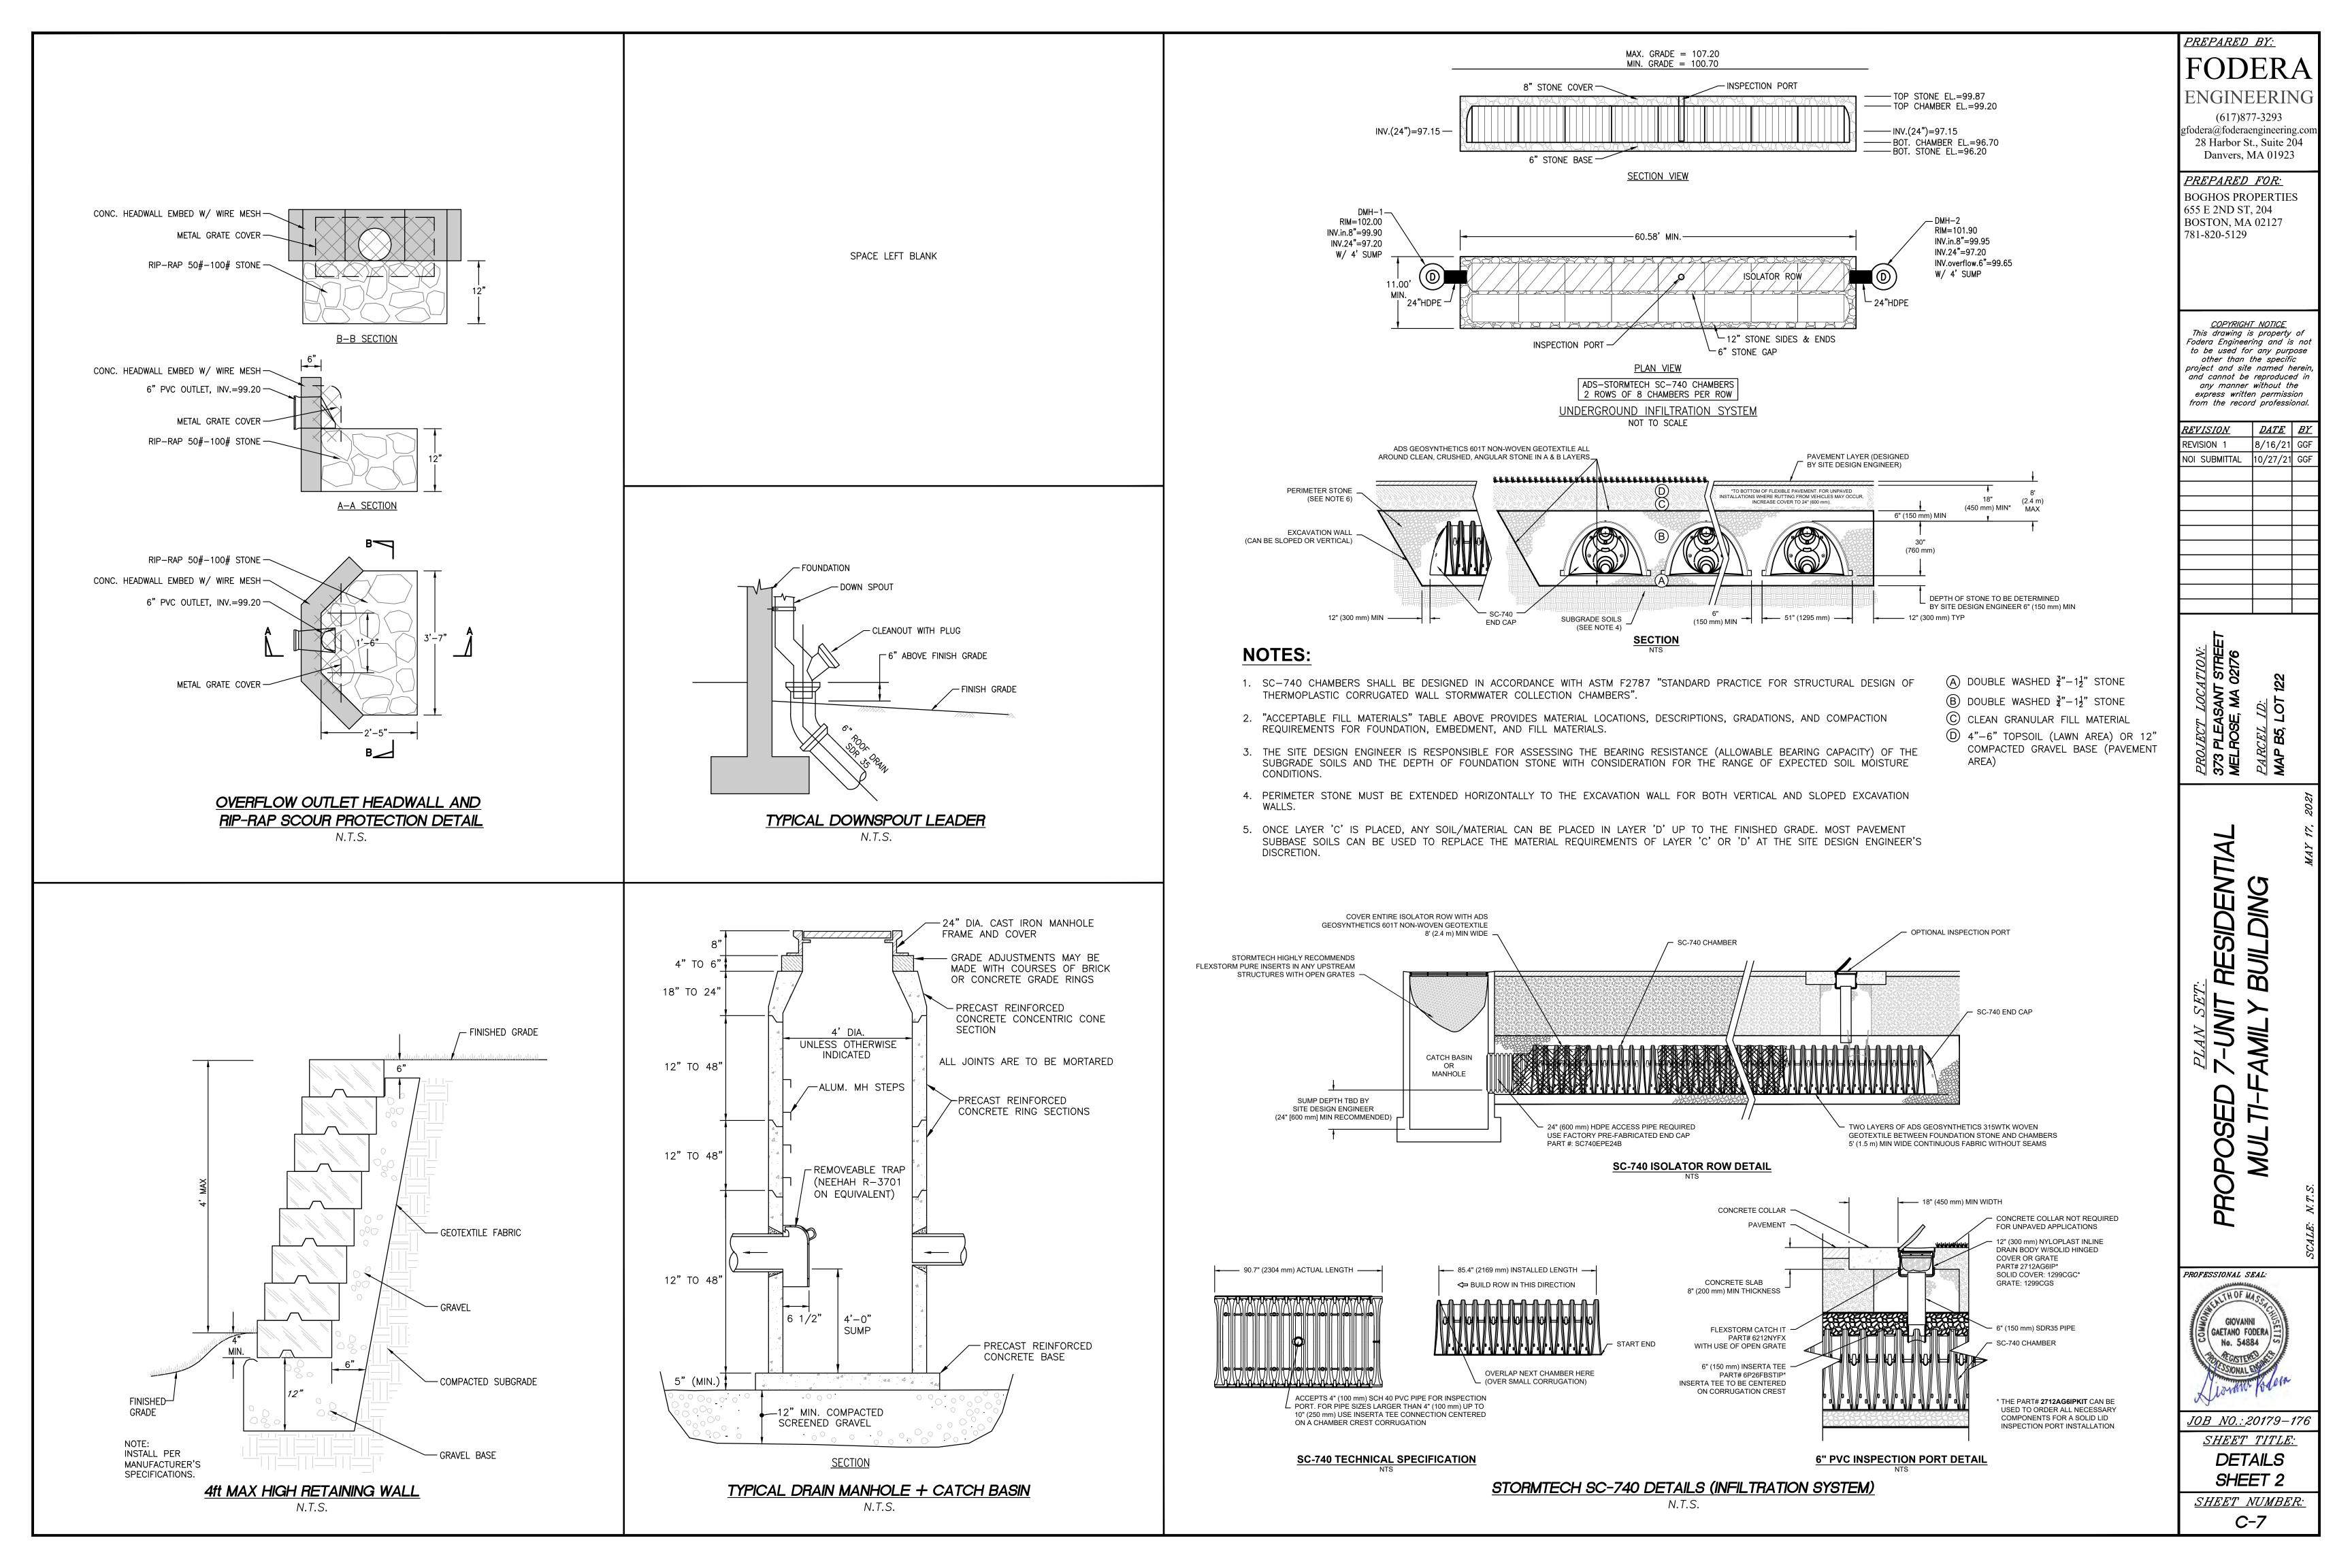

373 PLEASANT STREET

MELROSE, MA

LANDSCAPE DESIGN PACKAGE



MICHAEL D'ANGELO landscape architecture





AUGUST 16, 2021

PROPERTY LINE

373 PLEASANT STREET

PROPERTY LINE





MICHAEL D'ANGELO landscape architecture



VIEW LOOKING NORTHEAST TOWARD PLEASANT STREET




VIEW LOOKING NORTH AT 373 PLEASANT STREET



AUGUST 16, 2021

VIEW LOOKING EAST TOWARD 373 PLEASANT STREET

VIEW LOOKING SOUTHWEST TOWARD 373 PLEASANT STREET

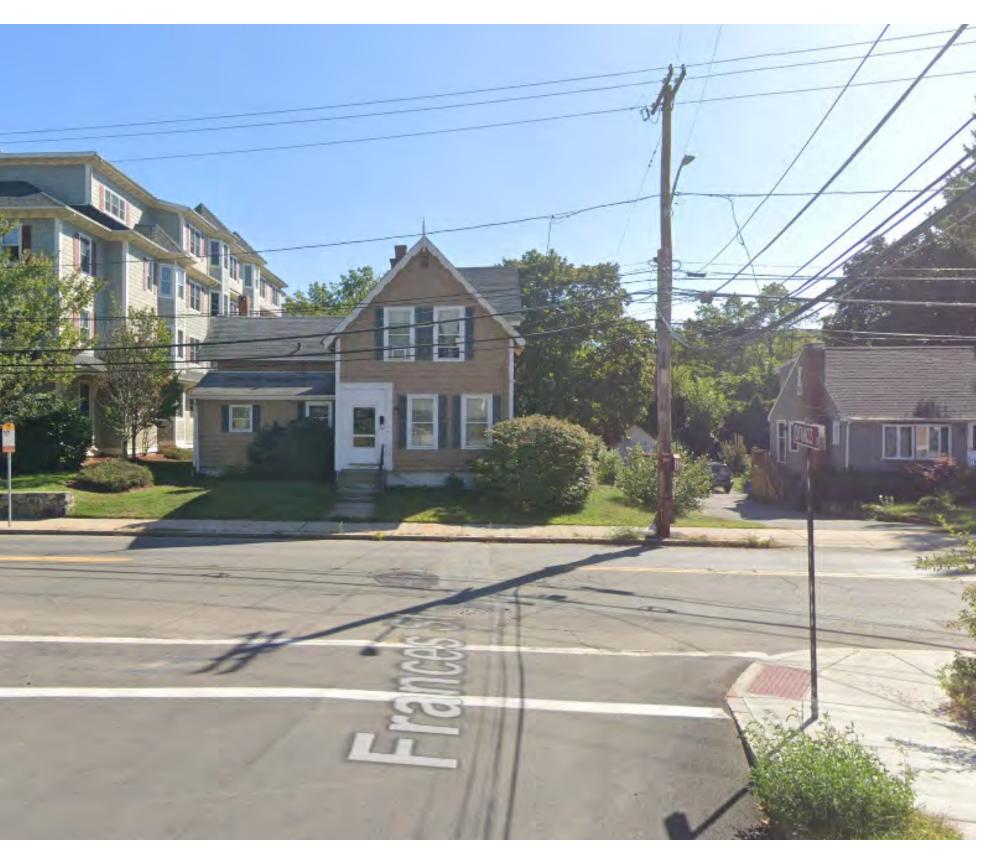


VIEW LOOKING EAST FROM FRANCES STREET TOWARD 373 PLEASANT



VIEW LOOKING WEST AT 373 PLEASANT STREET



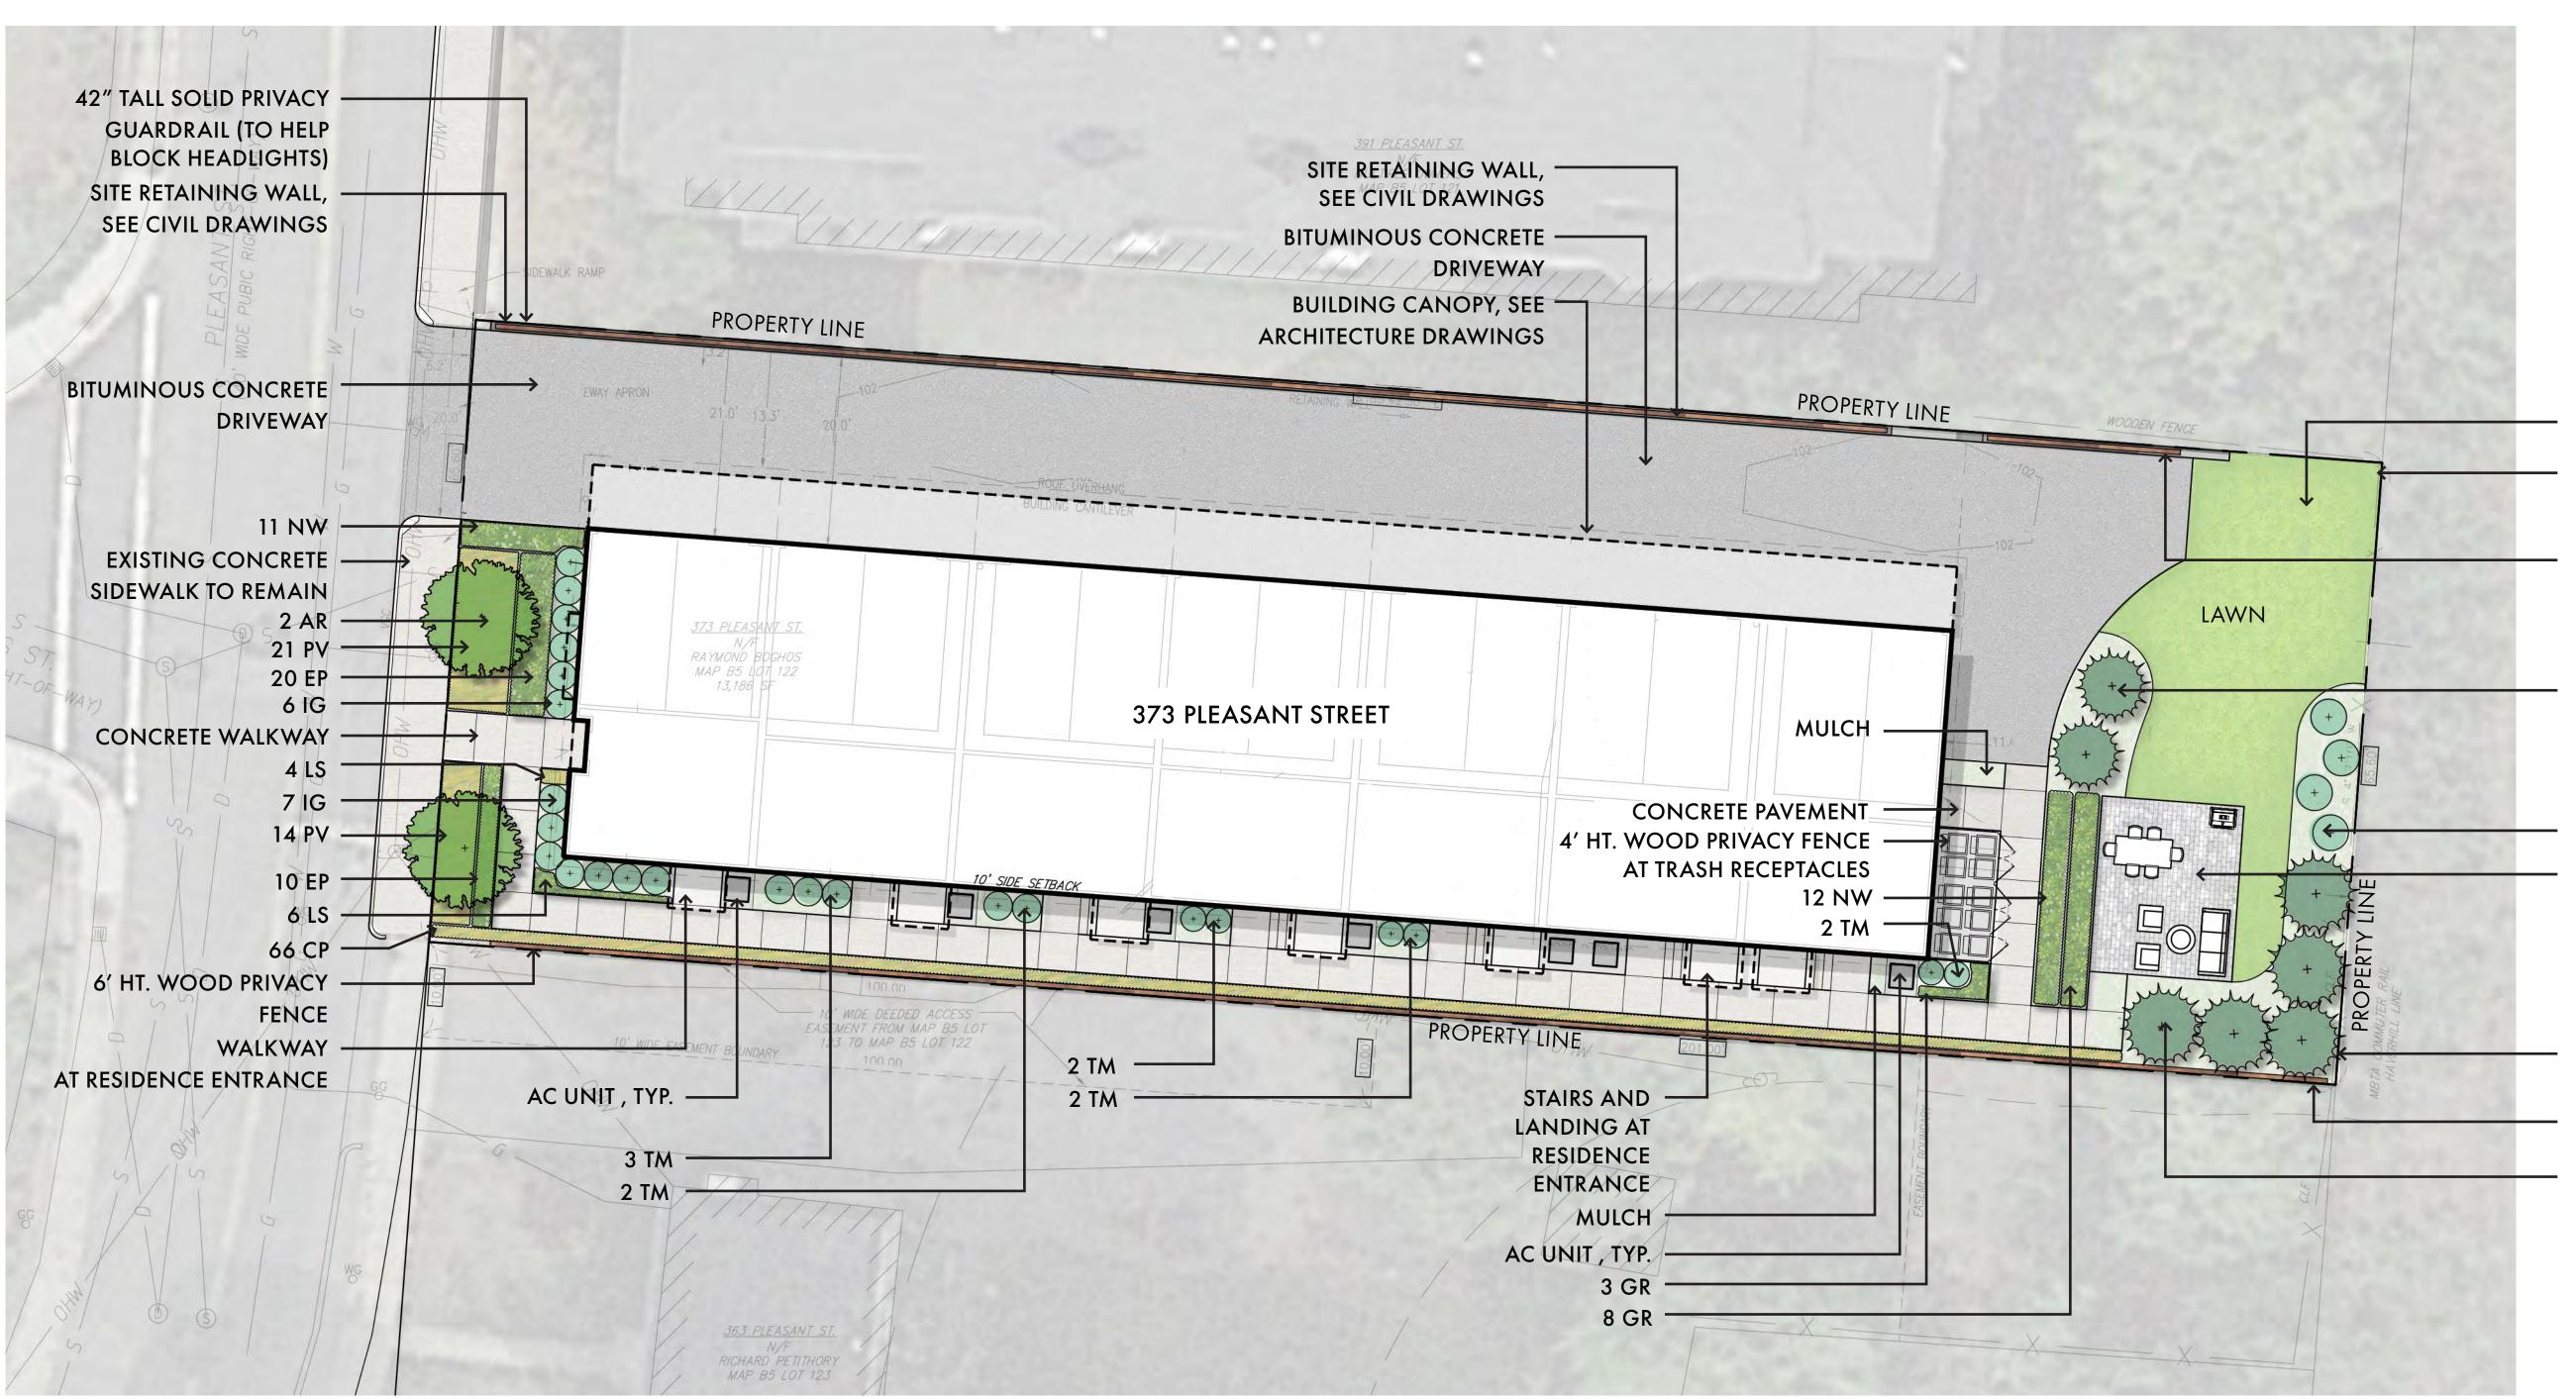

PLANT SCH	HEDULE					
SYMBOL	L QUANTITIES LATIN NAME		COMMON NAME	SIZE	NOTES	
SHADE TR	EES	•	•			
						+ +
AR	2	ACER RUBRUM 'ARMSTRONG'	RED SUNSET MAPLE	3"-3.5" CAL.	B&B, 6' CLEAR BRANCHING	الكور بالملا
						ಮರಿತಾ
EVERGREE	EN TREES					July _
						$-\frac{1}{2}$ $\frac{1}{2}$
AC	5	ABIES CONCOLOR	WHITE FIR	7-8' TALL		<u> </u>
TP	2	THUJA PLICATA 'GREEN GIANT'	GREEN GIANT ARBORVITAE	7-8' TALL		- Small
						, . 1
SHRUBS						_
10	12					
IG	13	ILEX GLABRA 'SHAMROCK'	INKBERRY	3' TALL	36" O.C. B&B	
IV	4	ILEX VERTICILLATA 'RED SPRITE'	WINTERBERRY	5 GALLON	3 CAL. B&B	⊙
TM	11	TAXUS X MEDIA 'HICKSII'	HICKS YEW	3' TALL	36" O.C. B&B	
PERENNIA	LS					
		i	1		1	
EP	30	ECHINACEA PURPUREA	PURPLE CONEFLOWER	1 GAL	24" O.C. CONTAINER	_
NW	22	NEPETA X FAASSENII 'WALKERS LOW'	'WALKERS LOW' CATMINT	1 GAL	24" O.C. CONTAINER	
GR	11	GERANIUM X ROZANNE	ROZANNE CRANSBILL	1 GAL	24" O.C. CONTAINER	
ORNAME	NTAL GRASS					
		1	-			
PV	35	PANICUM VIRGATUM 'SHENANDOAH'	SWITCH GRASS	1 GAL	30" O.C. CONTAINER	
LS	10	LIRIOPE SPICATA	LILY TURF	1 GAL	24" O.C. CONTAINER	
СР	66	CAREX PENSYLVATICA	PENNSYLVANIA SEDGE	1 GAL	24" O.C. CONTAINER	

373 PLEASANT STREET 13 - LANDSCAPE DESIGN

AUGUST 16, 2021

SNOW STORAGE LOCATION

EXISTING CHAIN LINK FENCE TO REMAIN

42" HT. TALL SOLID PRIVACY GUARDRAIL (TO HELP BLOCK HEADLIGHTS)

• 2 TP

4 IV

UNIT PAVEMENT AT AMENITY PATIO

EXISTING CHAIN LINK FENCE TO REMAIN 6' HT. WOOD PRIVACY FENCE 5 AC



MICHAEL D'ANGELO landscape architecture

